
PLANS FOR PROPOSED IMPROVEMENT


MAIN STREET STREETSCAPE FROM JEFFERSON STREET TO MULBERRY STREET CITY OF ROCKFORD WINNEBAGO COUNTY

PROJECT LOCATION MAP
CITY OF ROCKFORD
N.T.S.

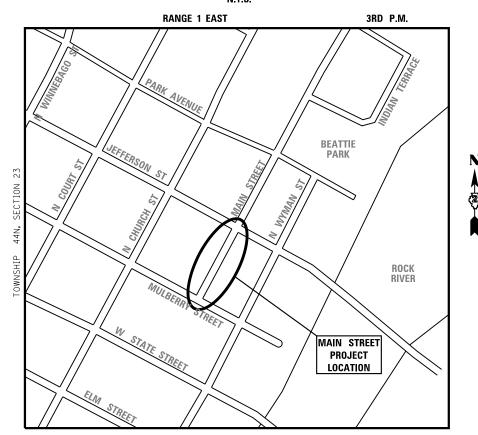

PROJECT LENGTH

GROSS LENGTH OF IMPROVEMENTS (MAIN STREET) = 330'

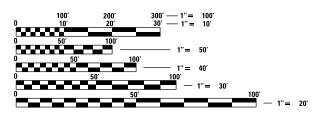


FULL SIZE PLANS HAVE BEEN PREPARED USING STANDARD ENGINEERING SCALES. REDUCED SIZED PLANS WILL NOT CONFORM TO STANDARD SCALES. IN MAKING MEASUREMENTS ON REDUCED PLANS, THE ABOVE SCALES MAY BE USED.


J.U.L.I.E. JOINT UTILITY LOCATION INFORMATION FOR EXCAVATORS 1-800-892-0123 OR 811

PROJECT ENGINEER: MICHELLE ZUZZIO PROJECT MANAGER: JACK MELHUISH

CONTRACT NO.

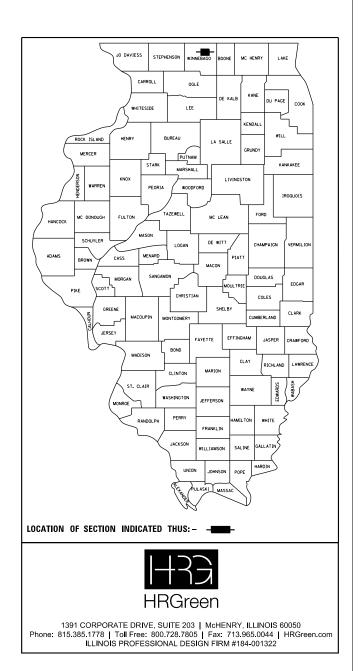

CITY OF ROCKFORD							
APPROVED _	(DATE)						
-	CITY OF ROCKFORD, CITY ENGINEER						

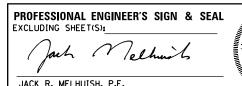

JACK R. MELHUISH, P.E. EXPIRES: 11-30-23



INDEX OF SHEETS

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State Standards and

Summary of Quantities General Notes

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Alignment, Ties & Benchmarks

Removal Plan

Proposed Sidewalk, Curb & Gutter Plan

Proposed Landscaping Plan 10-15 Proposed Lighting Plan

Details

17-20 District 2 Standard Details

21 Sidewalk Vault Closure

STATE STANDARDS

000001-07 STANDARD SYMBOLS, ABBREVIATION AND PATTERNS

001006 DECIMAL OF AN INCH AND OF A FOOT

701601-09 URBAN LANE CLOSURE, MULTILANE, 1W OR 2W WITH NONTRAVERSABLE MEDIAN

701801-06 SIDEWALK, CORNER OR CROSSWALK CLOSURE

TRAFFIC CONTROL DEVICES 701901-08

DISTRICT 2 STANDARDS

WORK ZONE SIGN DETAILS

UTILITY /AGENCY CONTACTS

COMED: AMIR MAHMUTAGIC (630) 437-2212 COMCAST: TOM YUCCAS (815 509-8653 (630) 338-2458 AT&T: PHIL PACE NICOR: SAKIBUL FORAH (630) 388-2903 ROCKFORD MASS DENNIS HENDRICKS JEN URIDIL-DOLMAN TRASNSIT DISTRICT: (815) 961-9000 FIBER: (630) 210-1367

LISA ZINGULA

	ITEM	UNIT	TOTAL
	TRAFFIC CONTROL AND PROTECTION, SPECIAL	LSUM	1
	DEBRIS REMOVAL	LSUM	1
.	GEOCOMPOSITE WALL DRAIN	SQ YD	37
	MASONRY WALL CONSTRUCTION	SQ FT	270
	CA-7 DRAINAGE STONE	TON	210
	FILTER FABRIC	SQ YD	42
.	INLET AND PIPE PROTECTION	EACH	2
	ADJUST WATER VALVE	EACH	4
	PORTLAND CEMENT CONCRETE SIDEWALK, 5-INCH	SQ FT	9284
(AGGREGATE BASE COURSE, TYPE B 4"	SQ YD	1178
(DETECTABLE WARNINGS	SQ FT	20
	COMBINATION CURB AND GUTTER REMOVAL	FT	80
	PLANTER CURB	EACH	10
(SIDEWALK REMOVAL	SQ FT	9343
	COMBINATION CONCRETE CURB AND GUTTER, TYPE M-6.18 (MODIFIED)	FT	80
	REMOVING AND RESETTING STREET SIGNS	EACH	1
	TUBULAR STEEL SIGN SUPPORT	FT	160
(SIGN PANEL, TYPE 1	SQ FT	44
	TREE AND GRATE REMOVAL	EACH	7
	REMOVE AND RELOCATE TRASH RECEPTACLE	EACH	1
.	REMOVE AND RELOCATE PARK BENCH	EACH	1
-	STAMPED, COLORED PORTLAND CEMENT CONCRETE SIDEWALK, 5 INCH	SQ FT	1315
	GINKO BILOBA / MAIDENHAIR TREE, 2.5" CALIPER	EACH	8
.	ULMUS X'FRONTIER' / FRONTIER ELM, 2.5" CALIPER	EACH	2
(PERENNIALS, #1 CONTAINER	EACH	160
	GRASSES, #1 CONTAINER	EACH	20
	CONSTRUCTION LAYOUT STAKES	LSUM	1
	MOBILIZATION	LSUM	1
(UNDERGROUND CONDUIT, GALVANIZED STEEL, 4" DIA.	FOOT	117
(UNIT DUCT ,600V,4-1C NO.4,1/C NO.6 GROUND (XLP-TYPE USE),1 1/2" DIA. POLYETHYENE	FOOT	703
(ELECTRIC CABLE IN CONDUIT, 600V (XLP-TYPE USE) 1/C NO. 6	FOOT	275
	ELECTRIC CABLE IN CONDUIT, 600V (XLP-TYPE USE) 1/C NO. 4	FOOT	1925
	LIGHT POLE FOUNDATION, 24" DIAMETER	FOOT	14
(REMOVAL OF LIGHTING UNIT, SALVAGE	EACH	5
(REMOVAL OF POLE FOUNDATION	EACH	5
	REMOVE EXISTING HANDHOLE	EACH	5
(DRILL EXISTING HANDHOLE	EACH	1
ξ.	LUMINAIRE, LED, SPECIAL	EACH	14
	LIGHT POLE , SPECIAL	EACH	14

SEE SPECIAL PROVISIONS

N.T.S.

SPECIALTY ITEM

HRGreen.com HRGreen,

WINDSTREAM:

USER NAME - mzuzzio	DESIGNED - MLZ_	REVISED	-	XX/XX/XXXX
	CHECKED - DMS_	REVISED	-	XX/XX/XXXX
PLOT SCALE =	DRAWN	REVISED	-	XX/XX/XXXX
PLOT DATE = 6/14/2022	CHECKED	REVISED	-	XX/XX/XXXX

(800) 289-1901

GENERAL NUTES, INDEX OF SHEETS, DISTRICT 2 DETAILS,	F.A RTE.	SECTION	COUNTY	TOTAL SHEETS	
STATE STANDARDS & SUMMARY OF QUANTITIES			WINNEBAGO	21	2
MAIN STREET			CONTRACT	NO	
N.T.S. 2 SHEET2NO OF SHEETS		ILLINOIS F	ED. AID PROJECT		

GENERAL NOTES

- IT SHALL BE THE RESPONSIBILITY OF THE CONTRACTOR TO REMOVE AND DISPOSE OF ALL MATERIAL AND DEBRIS, RESULTING FROM CONSTRUCTION OPERATIONS. THE COST FOR THE REMOVAL AND DISPOSAL OF ALL CONSTRUCTION RELATED DEBRIS SHALL BE INCLUDED IN THE CONTRACT AND NO ADDITIONAL COST WILL BE
- REMOVAL OF PAVEMENT, SIDEWALK, CURB AND GUTTER, ETC SHALL BE DISPOSED OF OFF SITE AT LOCATIONS PROVIDED BY THE CONTRACTOR AT NO ADDITIONAL COST
- DURING CONSTRUCTION OPERATIONS, WHENEVER ANY LOOSE MATERIAL IS PRESENT IN THE FLOW LINE OF GUTTERS, DRAINAGE STRUCTURES, ETC SUCH THAT THE NATURAL FLOW LINE OF WATER IS OBSTRUCTED, THE LOOSE MATERIAL SHALL BE REMOVED AT THE END OF EACH WORKING DAY. AT THE CONCLUSION OF CONSTRUCTION OPERATIONS, ALL DRAINAGE STRUCTURES AND FLOW LINE SHALL BE FREE FROM DIRT AND DEBRIS. THIS WORK SHALL BE IN THE CONTRACT, AT NO ADDITIONAL COST TO THE OWNER. THE CONTRACTOR'S FAILURE TO PROVIDE THE ABOVE WILL PRECLUDE ANY POSSIBLE ADDED COMPENSATION REQUESTED DUE TO DELAYS. DELAYS, OR REMOVAL OF UNSUITABLE MATERIALS CREATED AS A RESULT THEREOF
- CONTRACTOR SHALL PROVIDE A MINIMUM OF 48 HOURS ADVANCE NOTICE TO RESIDENT ENGINEER FOR ALL WORK TO BE PERFORMED IN ACCORDANCE WITH THE
- WHERE SECTION OR SUB-SECTION MARKERS ARE ENCOUNTERED, THE ENGINEER SHALL BE NOTIFIED BEFORE SUCH MONUMENTS ARE REMOVED. THE CONTRACTOR SHALL PROTECT AND CAREFULLY PRESERVE ALL PROPERTY MARKERS AND MONUMENTS UNTIL THE OWNER, AND AUTHORIZED AGENT OR LAND SURVEYOR HAS WITNESSED OR OTHERWISE REFERENCED THEIR LOCATION.
- MAINTENANCE OF TRAFFIC SHALL BE PERFORMED IN ACCORDANCE WITH THE SPECIAL PROVISIONS, STANDARD SPECIFICATIONS FOR ROAD AND BRIDGE CONSTRUCTION, SECTION 107.14. THE APPLICABLE GUIDELINES IN THE IDOT MANUAL ON UNIFORM TRAFFIC CONTROL DEVICES FOR STREETS, DETAILS IN THE PLANS, AND APPROPRIATE HIGHWAY STANDARDS. THIS WORK WILL BE PAID FOR AS TRAFFIC CONTROL AND PROTECTION (SPECIAL), (LUMP SUM PAYMENT), UNLESS OTHERWISE
- THE CONTRACTOR SHALL NOT MOUNT CONSTRUCTION TRAFFIC CONTROL SIGNS ON EXISTING
- THE CONTRACTOR SHALL CONTACT THE CITY OF ROCKFORD AT LEAST SEVENTY-TWO (72) HOURS IN ADVANCE OF BEGINNING ANY WORK.
- THE CONTRACTOR SHALL MAINTAIN ACCESS TO PRIVATE ENTRANCES ALONG THE LIMITS OF CONSTRUCTION, UNLESS OTHERWISE NOTED.
- THE CONTRACTOR'S OPERATIONS AND TEMPORARY STORAGE ACTIVITIES SHALL BE LIMITED TO THE WORK AREA AND/OR CONSTRUCTION LIMITS.
- ALL CONSTRUCTION SHALL BE DONE IN ACCORDANCE WITH THE LATEST EDITION IN EFFECT ON THE DATE OF INVITATION FOR BIDS, OF THE FOLLOWING: "STANDARD SPECIFICATIONS FOR ROAD AND BRIDGE CONSTRUCTION": HEREINAFTER REFERRED TO AS THE "STANDARD SPECIFICATIONS": THE "ILLINOIS MANUAL ON UNIFORM TRAFFIC CONTROL DEVICES FOR STREETS AND HIGHWAYS": THE "SUPPLEMENTAL SPECIFICATIONS AND RECURRING SPECIAL PROVISIONS': AND THE "SPECIAL PROVISIONS" INCLUDED IN THE CONTRACT DOCUMENTS. IN CASE OF DISCREPANCIES BETWEEN SPECIFICATIONS, THE CONTRACTOR SHALL SECURE WRITTEN INSTRUCTIONS FROM THE ENGINEER PRIOR TO PROCEEDING WITH ANY PART OF THE WORK AFFECTED BY OMISSIONS OR DISCREPANCIES. FAILING TO SECURE SUCH INSTRUCTIONS, THE CONTRACTOR WILL BE CONSIDERED TO HAVE PROCEEDED AT HIS OWN RISK AND EXPENSE. IN THE EVENT OF ANY DOUBT OR QUESTION ARISING WITH RESPECT TO THE TRUE MEANING OF THE CONSTRUCTION PLANS OR SPECIFICATIONS, THE DECISION OF THE ENGINEER SHALL BE FINAL AND CONCLUSIVE.
- THE PROSPECTIVE BIDDER SHALL, BEFORE SUBMITTING A BID, CAREFULLY EXAMINE THE PROPOSAL FORM, PLANS, SPECIFICATIONS, SPECIAL PROVISIONS AND FORM OF CONTRACT AND BOND. THE BIDDER SHALL INSPECT IN DETAIL THE STREETS, THE SITE OF THE PROPOSED WORK AND THE LOCAL CONDITIONS THAT AFFECT THE DETAILED REQUIREMENTS OF CONSTRUCTION. THIS SHALL INCLUDE, BUT NOT BE LIMITED TO, THE VARIOUS PAVEMENT CROSS SECTIONS, THE CONDITION OF THE PAVEMENTS, UTILITIES THAT ARE KNOWN, UNKNOWN OR ABANDONED, UNIDENTIFIED VAULTS OR CAVITIES WITHIN THE RIGHT-OF-WAY AND ITEMS BURIED WITHIN THE RIGHT-OF-WAY INCLUDING UTILITY STRUCTURES.
- SAW CUTTING WILL BE REQUIRED FOR ALL REMOVAL ITEMS AND SHALL BE TO FULL DEPTH AND SHALL RESULT IN A CLEAN STRAIGHT EDGE IN THE PORTION REMAINING. THE COST OF SAW CUTTING WILL BE INCLUDED IN CONTRACT UNIT BID PRICES FOR THE ITEMS BEING REMOVED.
- REMOVAL AND REPLACEMENT OF EXISTING COMBINATION CURB AND GUTTER, REGARDLESS OF CURB AND GUTTER TYPE, SHALL BE PAID FOR AS "COMBINATION CURB AND GUTTER REMOVAL AND REPLACEMENT".
- WHERE NEW WORK MEETS EXISTING FEATURES TO REMAIN, FIELD CHECK ALL DIMENSIONS AND ELEVATIONS BEFORE PROCEEDING WITH CONSTRUCTION, NOTIFY ENGINEER IMMEDIATELY OF ANY DISCREPANCIES.
- OFFSET LOCATIONS GIVEN IN THE PLANS FOR EDGE OF PAVEMENT, ETC. ARE FROM THE ROADWAY CENTERLINE.

UTILITY NOTES

- FORTY-EIGHT HOURS BEFORE STARTING EXCAVATION THE CONTRACTOR SHALL CALL
 J.U.L.I.E. TO HAVE THE LOCATION OF EXISTING UTILITIES STAKED.
- 2. THE CONTRACTOR SHALL COORDINATE CONSTRUCTION ACTIVITIES WITH UTILITY COMPANIES AND THE CITY OF ROCKFORD.
- 3. THE CONTRACTOR SHALL BE RESPONSIBLE FOR PROTECTING UTILITY FACILITIES FROM CONSTRUCTION OPERATIONS AS OUTLINED IN ARTICLE 107.31 OF THE

- 4. THE LOCATION OF BURIED AND ABOVE GROUND UTILITIES SHOWN ON THE PLANS IS FOR THE CONTRACTORS: INFORMATION ONLY AND IS NOT IMPLIED TO BE REFERENCED FOR CONSTRUCTION PURPOSES. THE IMPLIED PRESENCE OR ABSENCE OF UTILITIES IS NOT TO BE CONSTRUED BY THE OWNER, ENGINEER, CONTRACTOR OR SUB-CONTRACTOR TO BE AN ACCURATE AND COMPLETE REPRESENTATION OF UTIL
 ITIES THAT MAY OR MAY NOT EXIST ON THE CONSTRUCTION SITE. IT SHALL BE
 THE CONTRACTOR'S RESPONSIBILITY TO COORDINATE HIS CONSTRUCTION
 ACTIVITIES WITH THE VARIOUS UTILITY OWNERS. ALL POTENTIAL CONFILICTS
 SHALL BE INVESTIGATED AND REMEDIAL ACTION TAKEN PRIOR TO INTERRUPTION
 OF THE CONTRACTOR'S PROGRESS
- 5. ALL UTILITY FACILITIES THAT REQUIRE RELOCATION WITHIN CITY R.O.W. SHALL BE COMPLETED BY THE UTILITY COMPANY UNLESS OTHERWISE SHOWN ON THE PLANS.
- 6. WHEN THE PLANS OR SPECIAL PROVISIONS INCLUDE INFORMATION PERTAINING TO THE LOCATION OF THE EXISTING UTILITY FACILITIES, SUCH INFORMATION ONLY REPRESENTS THE OPINION OF THE ENGINEER AS TO THE LOCATION OF SUCH FACILITIES AND IS ONLY INCLUDED FOR THE CONTRACTOR'S CONVENIENCE. THE ENGINEER AND THE OWNER ASSUME NO RESPONSIBILITY FOR THE SUFFICIENCY OR ACCURACY OF THE INFORMATION SHOWN IN THE PLAN RELATING TO THE LOCATION THE EXISTING FACILITIES OR THE MANNER IN WHICH THEY ARE TO BE REMOVED
- 7. IT IS THE CONTRACTOR'S RESPONSIBILITY TO CONFIRM OR ESTABLISH THE EXISTE NCE OF ALL UTILITY FACILITIES RELEVANT TO THEIR EXACT LOCATIONS AND TO SCHEDULE ALL NECESSARY UTILITY RELOCATIONS.
- 8. THE CONTRACTOR IS RESPONSIBLE FOR VERIFYING THE NATURE OF AND STATUS OF ALL UTILITY RELOCATION WORK PRIOR TO THE START OF CONSTRUCTION. THE C ONTRACTOR SHALL TAKE APPROPRIATE MEASURES TO ENSURE THAT CONSTRUCTION ACTIVITIES DO NOT INTERFERE WITH UTILITY FACILITIES AND RELOCATION WORK. THE CONTRACTOR'S SCHEDULE SHOULD REFLECT CONSTRUCTION SEQUENCES WHICH COORDINATES WITH ALL UTILITY RELOCATION WORK. THE CONTRACTOR SHALL BE REQUIRED TO ADJUST THE SEQUENCE SCHEDULE OF WORK TO COORDINATE WITH THE RELOCATION SCHEDULED OF CONFLICTING UTILITY COMPANIES.

MAINTENANCE OF TRAFFIC

MAINTENANCE OF TRAFFIC SHALL BE IN TWO STAGES. THE EAST SIDE IS STAGE ONE WHICH WILL INCLUDE ALL VAULT WORK. THE WEST SIDE IS STAGE 2. MAINTENANCE OF TRAFFIC WILL FOLLOW IDOT HIGHWAY STANDARD 701601-09 FOR CLOSURE OF THE ADJACENT PARKING LANE DURING EACH STAGE. SIDEWALK CLOSURES WILL USE STANDARD 701801-06. PEDESTRIAN ACCESS MUST BE MAINTAINED TO BUILDING ENTRANCES.

TEMPORARY CHAIN LINK FENCE SHALL BE INSTALLED AS SHOWN ON THE PLANS OR AS DIRECTED BY THE ENGINEER DURING THE SIDEWALK VAULT CLOSURE CONSTRUCTION. TEMPORARY CHAIN LINK FENCE WILL BE PAID FOR SEPARATELY AS TEMPORARY CHAIN LINK FENCE.


MAINTENANCE OF TRAFFIC NOTES

- THE TRAFFIC CONTROL PLAN SHALL SERVE AS A GUIDE FOR SAFE DIVERSION OF TRAFFIC DURING EXECUTION OF THIS CONTRACT. HOWEVER, THE CONTRACTOR MAY IMPROVE OR MODIFY THE TRAFFIC CONTROL PLANS TO MEET CONSTRUCTION NEEDS BUT NOT AT THE EXPENSE OF PUBLIC SAFETY OR CONVENIENCE. ANY CHANGES TO THE TRAFFIC CONTROL PLAN SHALL BE SUBMITTED TO THE ENGINEER FOR APPROVAL.
- ALL OF THE TRAFFIC CONTROL DEVICES SHALL BE IN PLACE BEFORE CONSTRUCTION IS STARTED. ALL TRAFFIC CONTROL DEVICES SHALL BE IN PLACE AT THE BEGINNING OF EACH STAGE AND SHALL BE MAINTAINED FOR THE DURATION OF THAT STAGE UNLESS OTHERWISE DIRECTED BY THE ENGINEER.
- THE CONTRACTOR SHALL MAINTAIN TRAFFIC IN ACCORDANCE WITH THE PLANS, SPECIAL PROVISIONS, STATE STANDARDS AND AS DIRECTED BY THE ENGINEER.
- THE CONTRACTOR SHALL INFORM THE ENGINEER OF ANY CHANGES IN STAGING AT LEAST TWO (2) WORKING DAYS IN ADVANCE.
- TEMPORARY SIGNING, SHALL CONFORM TO THE APPLICABLE STANDARDS INCLUDED IN THE SPECIAL PROVISIONS AND CONTRACT PLANS OR AS DIRECTED BY THE ENGINEER.
- ALL "ROAD CONSTRUCTION AHEAD" SIGNS SHALL BE EQUIPPED WITH MONO-DIRECTIONAL AMBER FLASHING LIGHTS.
- EXISTING TRAFFIC CONTROL DEVICES WITHIN THE LIMITS OF CONSTRUCTION ARE TO BE PROTECTED FROM DAMAGE BY THE CONTRACTOR. ANY DAMAGED SIGNS CAUSED BY THIS WORK SHALL BE REPLACED BY THE CONTRACTOR.
- THE TYPE III BARRICADES ARE TO BE PLACED IN ACCORDANCE WITH STANDARD 701901 UNLESS AUTHORIZED BY THE ENGINEER TO USE AN ALTERNATIVE ARRANGEMENT.
- TYPE 1, TYPE II OR DRUM BARRICADES WITH TWO-WAY FLASHING LIGHTS SHALL BE REQUIRED AT ALL OPEN TRENCHES, EXCAVATIONS, OPEN OR EXPOSED SEWER STRUCTURES, TRANSVERSE PAVEMENT JOINTS, MATERIALS OR EQUIPMENT WITHIN THE RIGHT-OF-WAY (NUMBER AND SPACING DEPENDS ON THE CONDITIONS); AND AT LOCATIONS DESIGNATED BY THE ENGINEER OR LOCAL LAW ENFORCEMENT AGENCIES.
- THE CONTRACTOR SHALL PROVIDE, INSTALL, MAINTAIN AND REMOVE ALL SIGNS AND SIGN SUPPORTS REQUIRED FOR TRAFFIC CONTROL AND PROTECTION. THIS WORK SHALL NOT BE PAID FOR SEPARATELY BUT SHALL BE INCLUDED IN THE CONTRACT UNIT PRICE PER LUMP SUM FOR "TRAFFIC CONTROL AND PROTECTION (SPECIAL)".
- TRAFFIC CONDITIONS, ACCIDENTS, AND OTHER UNFORESEEN EMERGENCY CONDITIONS MAY REQUIRE THE ENGINEER TO RESTRICT, MODIFY, OR REMOVE LANE CLOSURES OR CHANNELIZATION SHOWN IN THE PLANS. THE CONTRACTOR SHALL MAKE THE NECESSARY ADJUSTMENTS AS DIRECTED BY THE ENGINEER WITHOUT DELAY. THE CONTRACTOR SHALL RESPOND TO ANY REQUEST MADE BY THE ENGINEER FOR CORRECTION WITHIN TWO HOURS FROM THE TIME OF NOTIFICATION.
- A DETECTABLE PEDESTRIAN CHANNELIZING BARRICADE WITH A "SIDEWALK CLOSED" SIGN AFFIXED, SHALL BE PLACED ON ALL SIDEWALKS CLOSED DUE TO CONSTRUCTION ACTIVITIES AS SHOWN IN STDS. 701801 & 701901.


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PLOT DATE = 5/17/2022	CHECKED -	REVISED - XX/XX/XXXX

GENERAL NOTES		SECT	ION		COUNTY	TOTAL SHEETS	SHE NC
MAIN STREET					WINNEBAGO	21	3
IVIAIN STREET					CONTRACT	NO.	
SHEET 2NO. OF SHEETS			ILLINOIS	FED. AI	D PROJECT		


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PLOT DRIVER: IL.pdf.bw.pltcfg

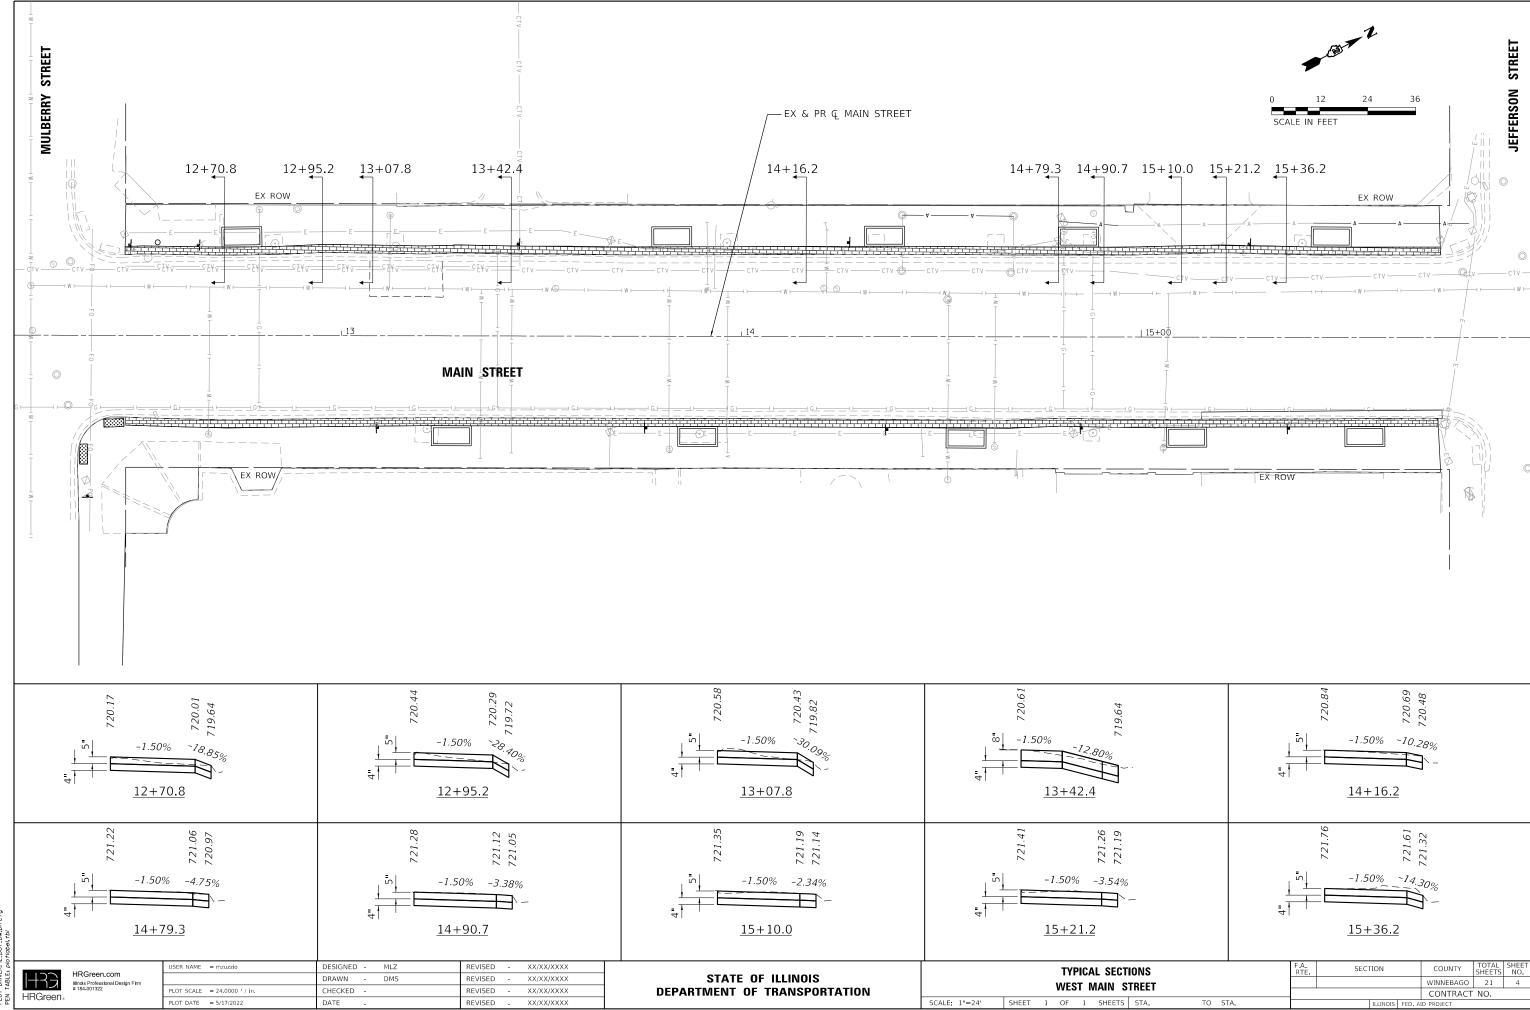

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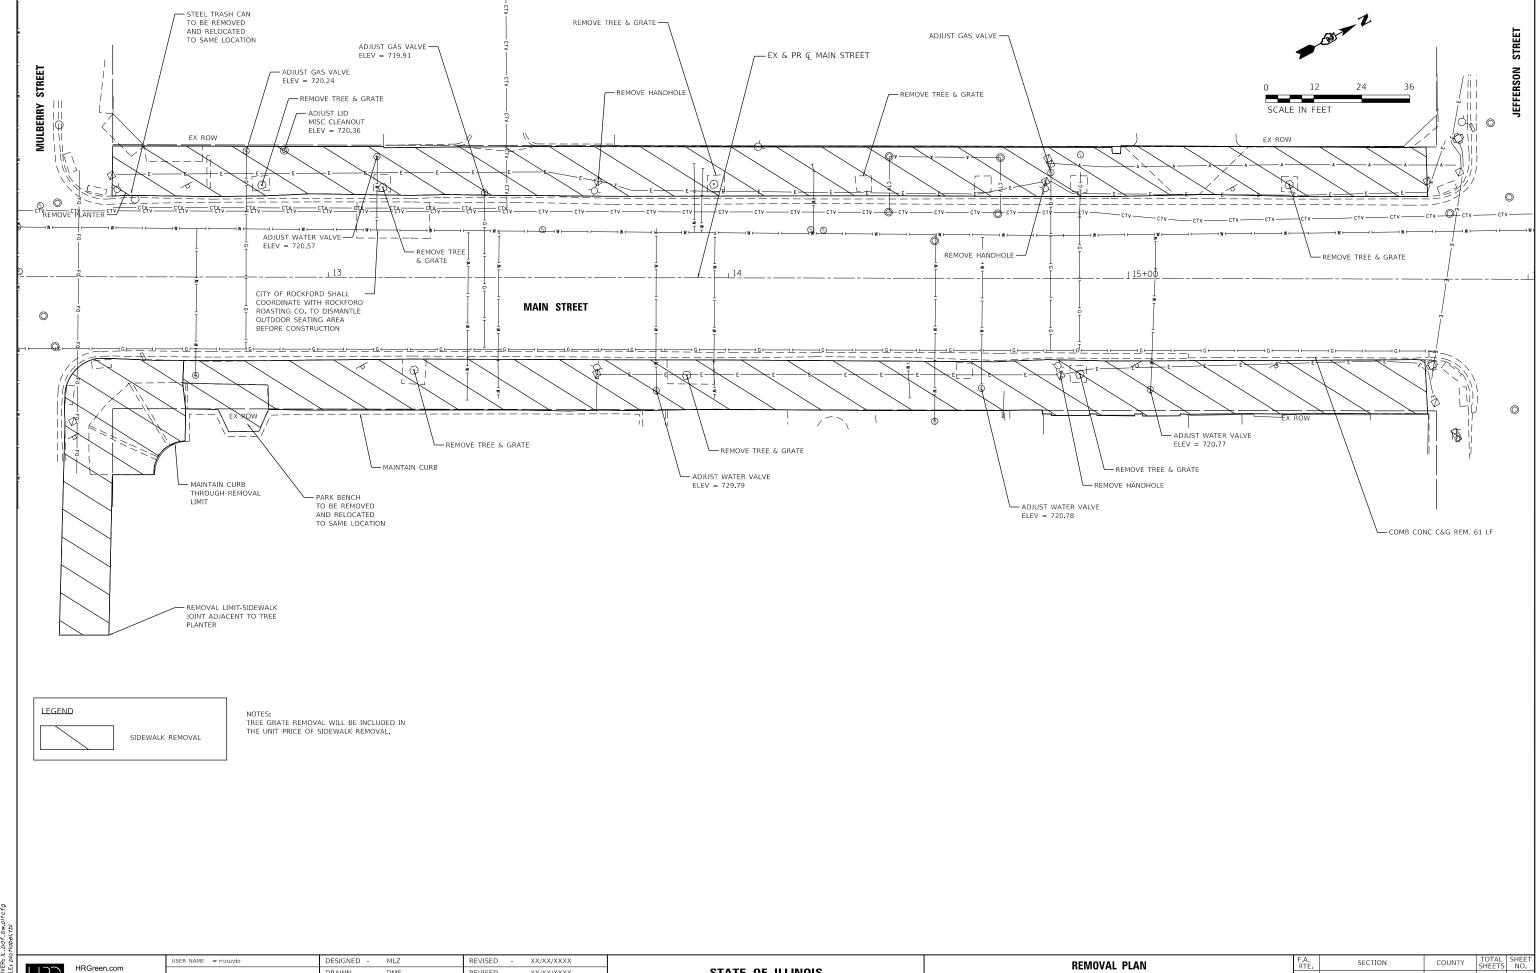
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HRGreen.com Illinots Professional Design Firm # 184-001322

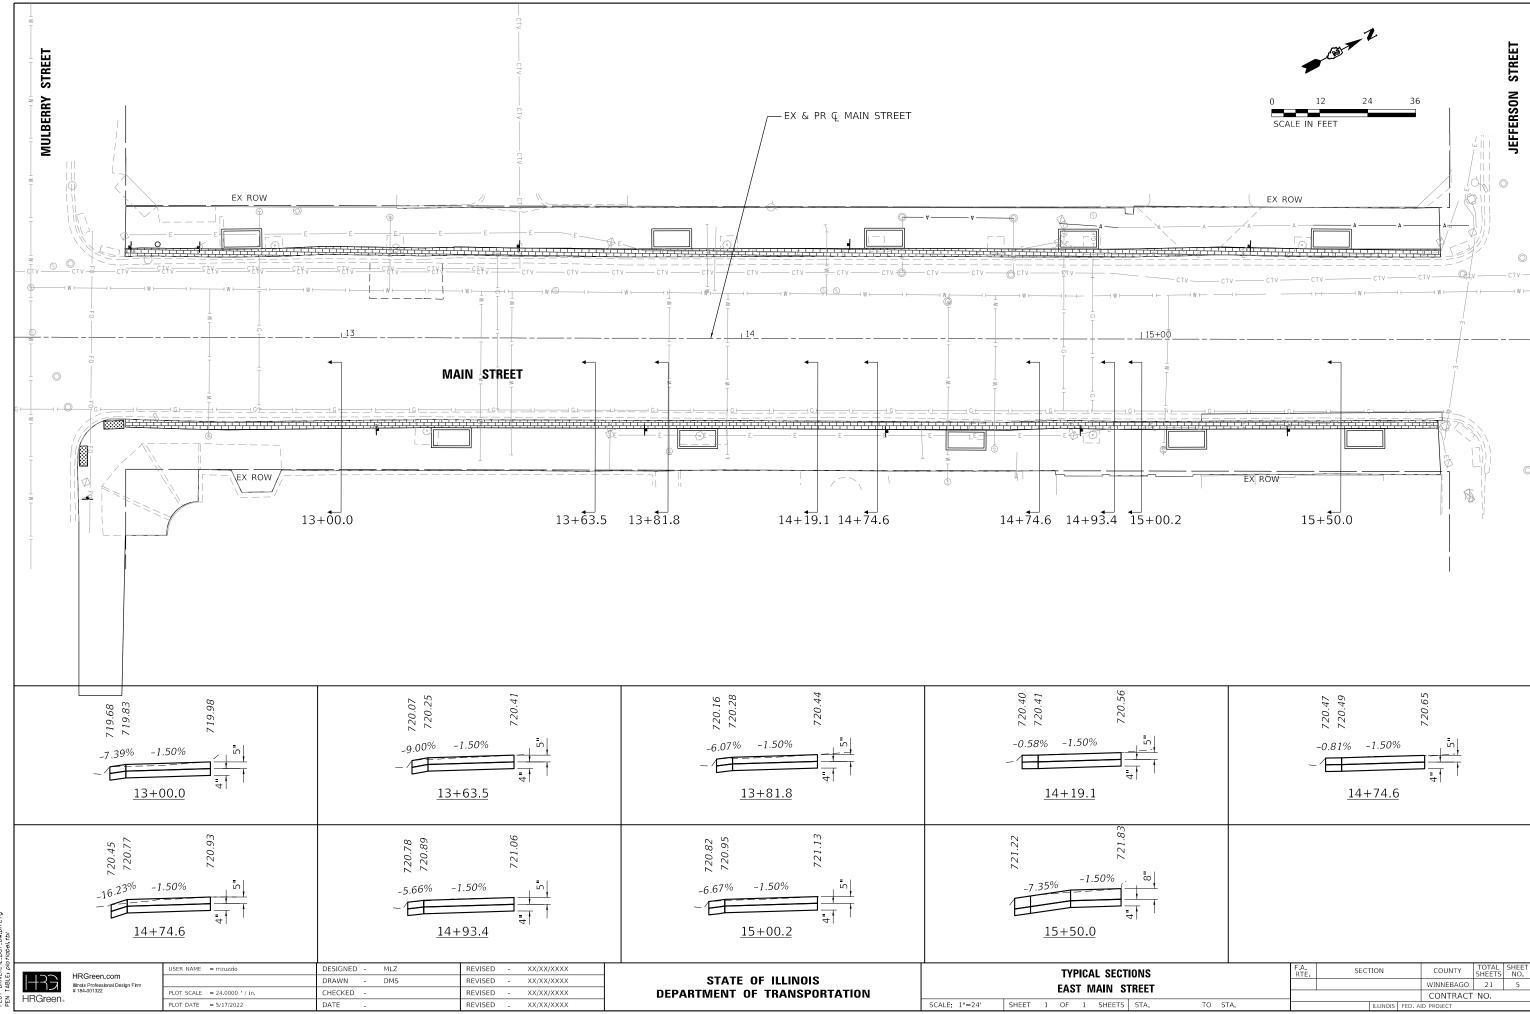USER NAME = mzuzzio	DESIGNED - MLZ	REVISED - XX/XX/XXXX
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PLOT DATE = 5/17/2022	DATE -	REVISED - XX/XX/XXXX

STATE OF ILLINOIS
DEPARTMENT OF TRANSPORTATION

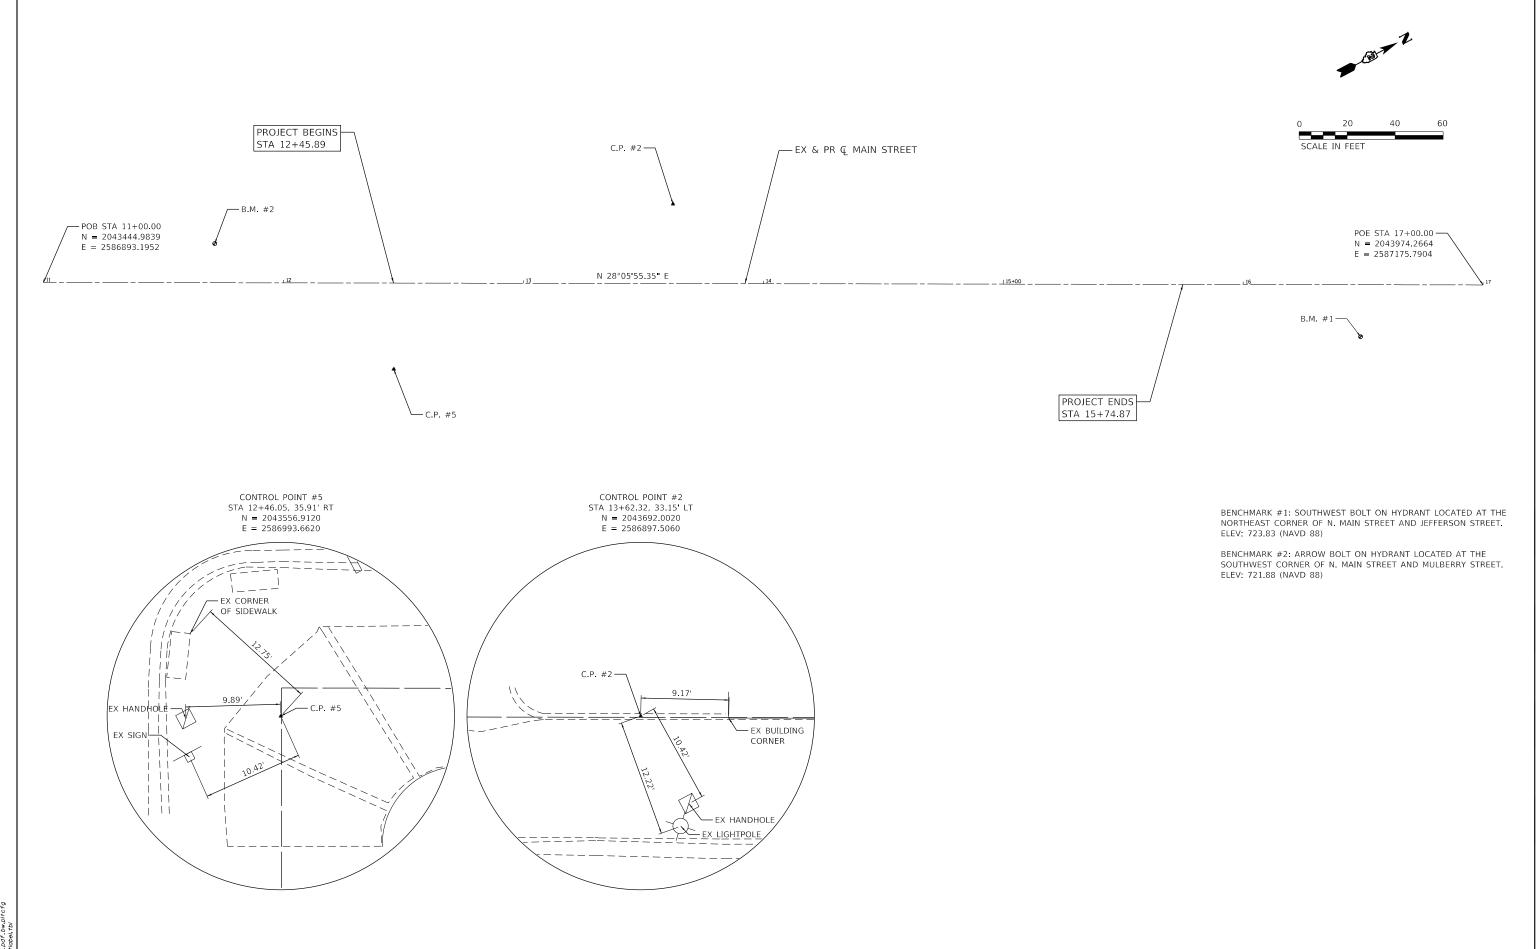ALIGNMENT, TIES & BENCHMARKS								F.A. RTE	SEC ⁻	TION		COUNTY	TOTAL SHEETS	SHEET NO.	
MAIN STREET												WINNEBAGO	21	6	
				VIAII	N JINL								CONTRACT	NO.	
SCALE: 1"=24"	SHEET	1	OF	1	SHEETS	STA.	TO	STA.			ILLINOIS	FED. A	ID PROJECT		





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PEN TABLE: p/otiabei.tb/

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#184-001322

STATE OF ILLINOIS
DEPARTMENT OF TRANSPORTATION

| REMOVAL PLAN | F.A. | SECTION | COUNTY | TOTAL SHEETS | N. | SHEETS | N. | SECTION | COUNTY | SHEETS | N. | SHEETS | N. | SECTION | COUNTY | SHEETS | N. | SHEETS | SHEETS | N. | SHEETS | SHEETS | N. | SHEETS | SHE

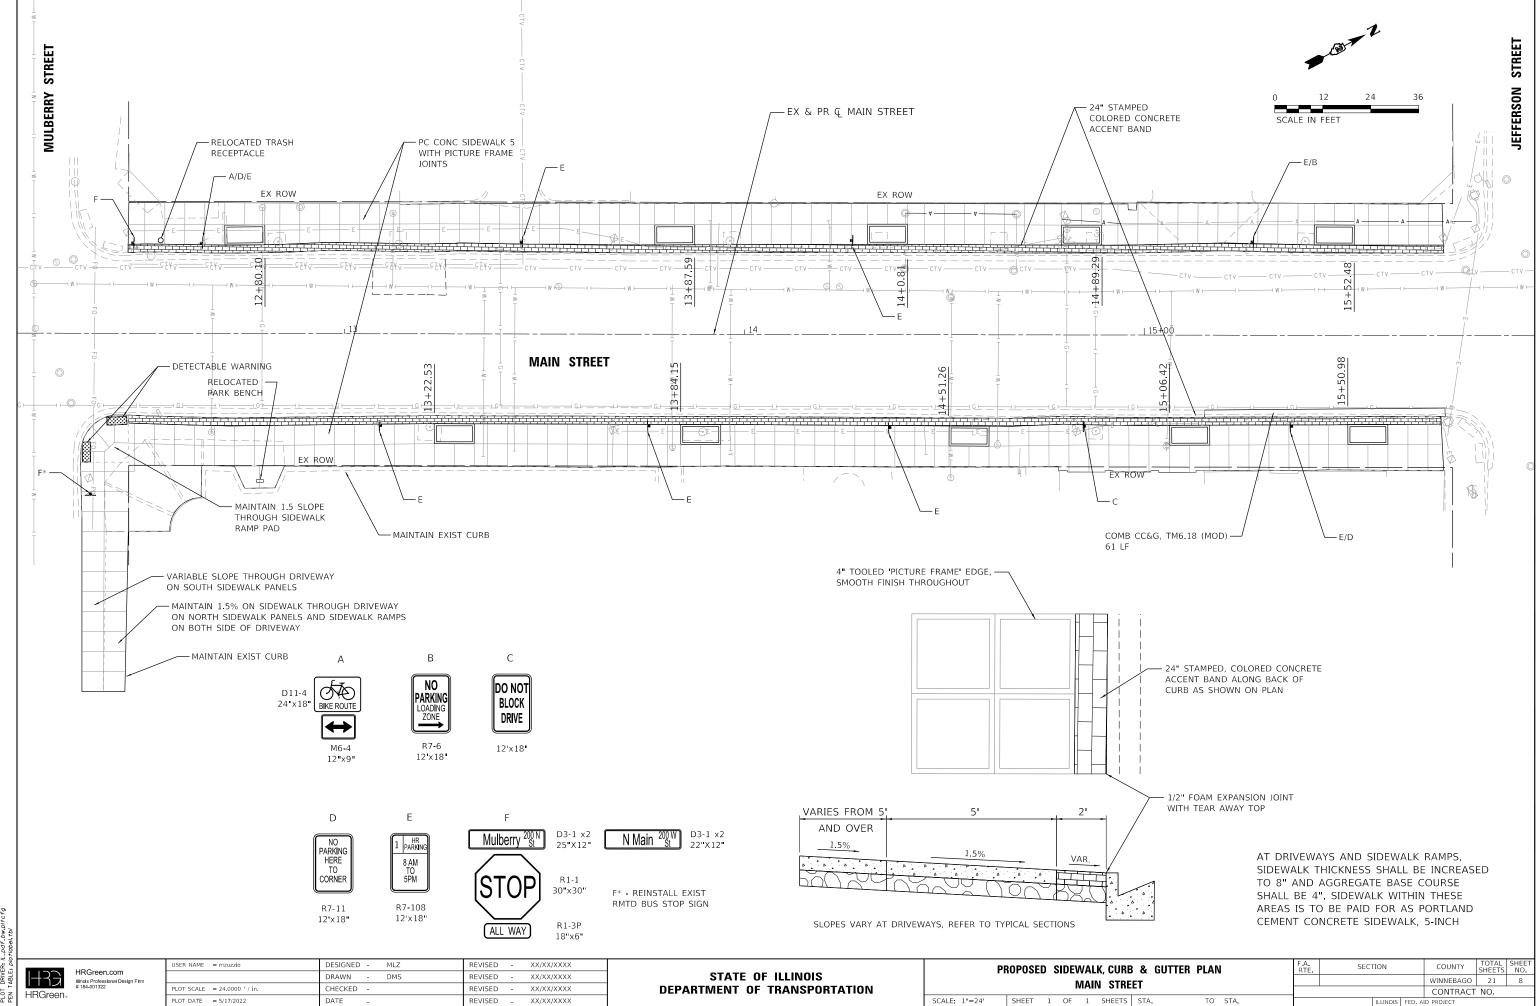

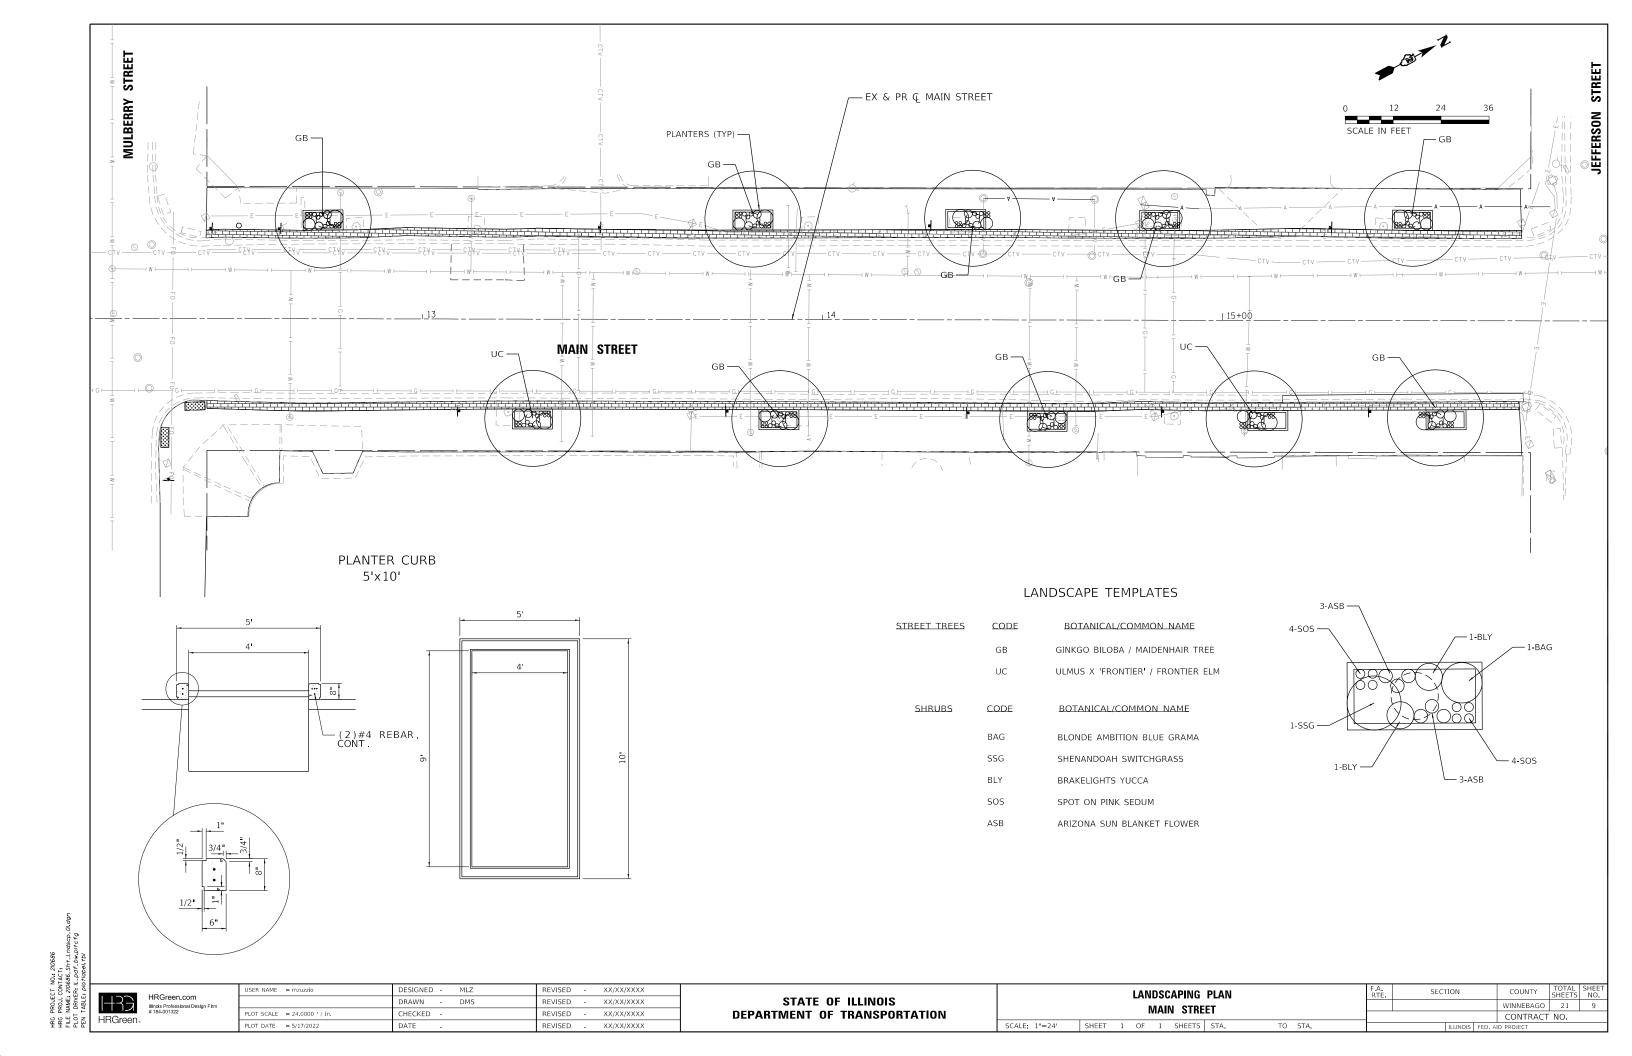

GENERAL NOTES:

- 1. THIS PROJECT INCLUDES THE REPLACEMENT OF EXISTING LIGHTING ON MAIN STREET FROM JEFFERSON STREET TO MULBERRY STREET BY USING STREETSCAPE LIGHTING UNITS AS APPROVED BY THE CITY OF ROCKFORD. THE PROPOSED DECORATIVE LIGHTING UNIT CONSISTS OF MAIN STREET LIGHTING UNIT, BANNER ARM, PLANTER ARM AND RECEPTACLE. IT SHALL BE OWNED AND MAINTAINED BY THE CITY OF ROCKFORD. THE CONTACT PHONE NUMBER OF ENGINEERING DIVISION OF THE CITY IS (779) 348-7300, AND THE ADDRESS IS 425 E. STATE STREET, ROCKFORD, IL 61104.
- 2. THERE SHALL BE NO CONSTRUCTION WORK INVOLVED ON MAIN STREET. HENCE THE TRAFFIC ON MAIN STREET SHALL BE CONTINUED DURING IMPROVEMENT OF SIDE WALKS AND STREET LIGHTING.
- 3. THE EXISTING ELECTRICAL FEED/CONTROLLER SHALL BE USED TO PROVIDE POWER FEED TO PROPOSED LIGHTING UNITS AND RECEPTACLES.
- 4. THE CONTRACTOR SHALL NOTIFY J.U.L.I.E. TO LOCATE AND MARK/STAKE ALL UNDERGROUND UTILITIES.
- 5. THE QUANTITIES OF RACEWAYS INDICATED ON LIGHTING PLAN ARE APPROXIMATIONS ONLY. THE CONTRACTOR SHALL FIELD VERIFY ALL LENGTHS AND SHALL INSTALL RACEWAYS IN COMPLETE COMPLIANCE WITH THE SPECIFIC REQUIREMENT.
- 6. LIGHTING SYSTEM INSTALLATION SHALL CONFORM TO THE LATEST IDOT STANDARDS, NEC AND LOCAL CODES.
- 7. ALL ELECTRICAL EQUIPMENT AND PRODUCTS SHALL BE UL LISTED AND LABELED.
- 8. THE CONTRACTOR SHALL TAKE CARE WHEN INSTALLING CONDUIT TO AVOID CONFLICTS WITH EXISTING UNDERGROUND UTILITIES AND TREES ROOTS. THE CONTRACTOR SHALL BE RESPONSIBLE FOR ANY DAMAGE AS DETERMINED BY THE ENGINEER.
- 9. THE CONTRACTOR SHALL TAKE CARE WHEN INSTALLING LIGHT POLE FOUNDATIONS TO AVOID CONFLICTS WITH UNDERGROUND UTILITIES. WHEN CONFLICTS ARE ENCOUNTERED, THE CONTRACTOR SHALL SUGGEST WHERE TO RELOCATE THE FOUNDATIONS. THE NEW LOCATION SHALL BE APPROVED BY THE ENGINEER PRIOR TO INSTALLATION.
- 10. GROUND RODS SHALL BE INSTALLED AT EACH OF THE LIGHTING UNITS.

BILL OF MATERIALS

PAY ITEM	DESCRIPTION	UNIT	QUANTITY
81028240	UNDERGROUND CONDUIT, GALVANIZED STEEL, 4" DIA.	FOOT	117
81603110	UNIT DUCT, 600V, 4-1C NO. 4, 1/C NO.6 GROUND (XLP-TYPE USE), 1 1/2" DIA. POLYETHYLENE	FOOT	703
81702130	ELECTRIC CABLE IN CONDUIT, 600V (XLP-TYPE USE) 1/C NO. 6	FOOT	275
81702140	ELECTRIC CABLE IN CONDUIT, 600V (XLP-TYPE USE) 1/C NO. 4	FOOT	1925
83600200	LIGHT POLE FOUNDATION, 24" DIAMETER	FOOT	14
84200500	REMOVAL OF LIGHTING UNIT, SALVAGE	EACH	5
84200804	REMOVAL OF POLE FOUNDATION	EACH	5
87900200	DRILL EXISTING HANDHOLE	EACH	1
89502380	REMOVE EXISTING HANDHOLE	EACH	5
X1400238	LUMINAIRE, LED, SPECIAL	EACH	14
X8300001	LIGHT POLE, SPECIAL	EACH	14

PROPOSED TYPE A DECORATIVE LIGHTING UNIT

PROPOSED TYPE B DECORATIVE LIGHTING UNIT WITH RECEPTACLE

EXISTING LIGHTING UNIT TO BE REMOVED

EXISTING LIGHTING UNIT TO REMAIN EXISTING HANDHOLE

EXISTING HANDHOLE TO BE REMOVED

ELECTRIC CABLE 600V, 7-1C NO. 4, 1/C NO. 6 GROUND OR AS SHOWN

(XLP-TYPE USE), IN CONDUIT

RIGID GALVANIZED STEEL CONDUIT WITH ELECTRIC CABLE OR UNIT DUCT

GROUND ROD


AMES Engineering, Inc. CONSULTING ENGINEERS 6330 Belmont Road, Suite 4B Downers Grove, IL 60515


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	DRAWN - SR	REVISED -
PLOT SCALE = \$SCALE\$	CHECKED - BL	REVISED -
PLOT DATE = \$DATE\$	DATE - 05-11-2022	REVISED -

SCALE:

GENERAL NOTES, LEGEND AND BILL OF MATERIALS MAIN STREET, CITY OF ROCKFORD								
	SHEET	OF	SHEETS	STA.	TO STA.			

					LT-	-1
E.	SECT	ΠΟN		COUNTY	TOTAL SHEETS	SHEET NO.
02				WINNEBAGO	21	10
				CONTRACT	NO.	
		ILLINOIS	FED. A	ID PROJECT		

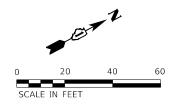

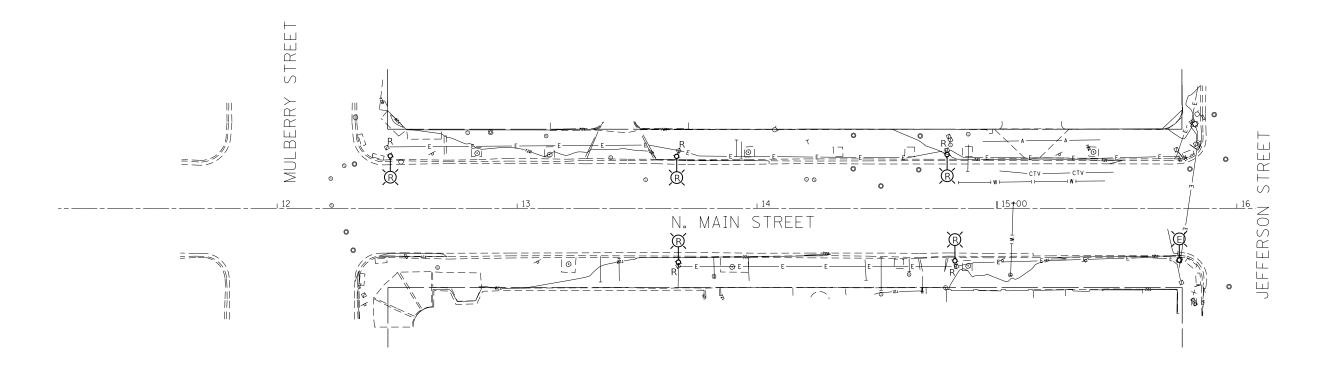

NOTES:

- 1. FOR GENERAL NOTES, BILL OF MATERIALS AND LEGEND, SEE SHEET LT-1.
- ALL ITEMS PERTAINING TO EXISTING LIGHTING INCLUDING ALUMINUM LIGHT POLES SHALL BE REMOVED AND RETURNED TO THE CITY OF ROCKFORD YARD EXCEPT CEMENT POLE.
- 3. THERE SHALL BE NO TEMPORARY LIGHTING ON MAIN STREET DURING CONSTRUCTION, AS PROPOSED WORK PERTAINING TO IMPROVEMENT OF SIDEWALKS. SO EXISTING LIGHTING ON ANY ONE SIDE OF MAIN STREET SHALL BE REMOVED WITH THE APPROVAL OF THE FIELD ENGINEER. EXISTING LIGHTING ON THE OPPOSITE SIDE SHALL BE USED AS TEMPORARY LIGHTING DURING CONSTRUCTION.
- 4. THE PROPOSED LIGHTING SHALL BE INSTALLED ON PRIORITY BASIS ON THE SIDE OF MAIN STREET WITHOUT ANY LIGHTING UNITS AS REMOVED EARLIER. WHEN THE PROPOSED LIGHTING IS INSTALLED COMPLETELY AND OPERATIONAL, THE EXISTING LIGHTING ON THE OTHER SIDE OF THE ROADWAY MAY BE REMOVED AND REPLACED WITH THE PROPOSED LIGHTING UNITS.


ı	Т-	-2


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	DRAWN - SR	REVISED -
PLOT SCALE = \$SCALE\$	CHECKED - BL	REVISED -
PLOT DATE = \$DATE\$	DATE - 05-11-2022	REVISED -

STATE OF ILLINOIS			
DEPARTMENT	0F	TRANSPORTATION	

SHEET

REMOVAL LIGHTING PLAN			F.A.U RTE	SECT	ION		COUNTY	TOTAL SHEETS	SHEET NO.		
MAIN STREET, CITY OF ROCKFORD			0002				WINNEBAGO	21	11		
							CONTRACT	NO.			
HEET	OF	SHEETS	STA.	TO STA.			ILLINOIS	FED. A	ID PROJECT		

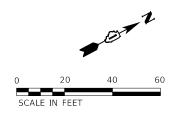

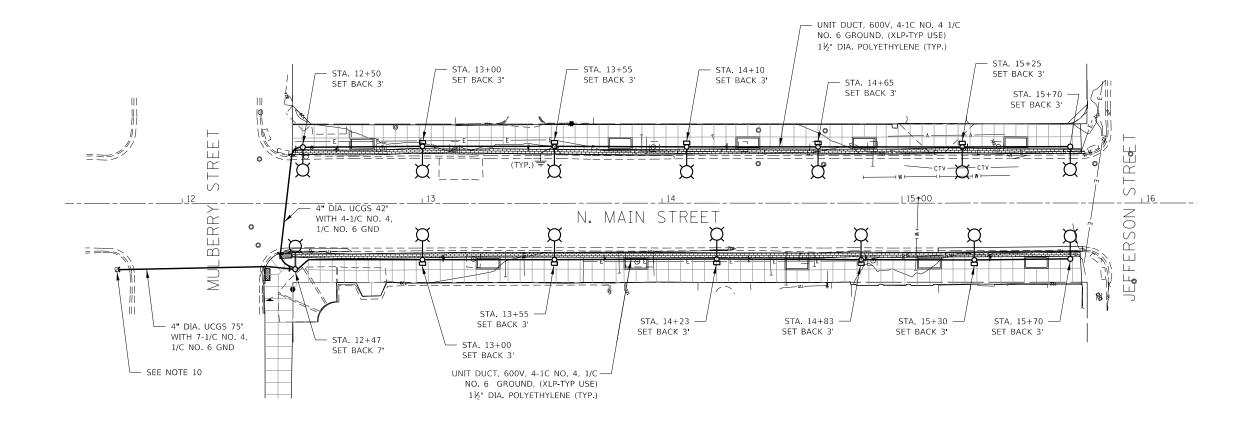

NOTES:

- 1. FOR GENERAL NOTES, BILL OF MATERIALS AND LEGEND, SEE SHEET LT-1.
- 2. FOR REMOVAL OF EXISTING LIGHTING ON MAIN STREET AND INSTALLATION OF PROPOSED LIGHTING, SEE NOTE 3 AND NOTE 4 ON SHEET- LT-2.
- 3. THE STREETSCAPE LIGHTING UNITS TYPE A POLES SHALL BE MOUNTED AT INTERSECTIONS OF MAIN STREET AND MULBERRY STREET AND JEFFERSON STREET. THE TYPE B LIGHT POLES SHALL BE INSTALLED ON BOTH SIDES OF MAIN STREET, PRACTICALLY OPPOSITE TO EACH OTHER.
- 4. TYPE A LIGHT POLES SHALL BE PROVIDED WITH ALUMINUM BANNER ARMS AND TYPE B LIGHT POLES SHALL BE PROVIDED WITH PLANTER ARMS BY THE MANUFACTURER. THE TYPE B LIGHT POLES SHALL ALSO BE PROVIDED WITH 120V GFCI WEATHERPROOF RECEPTACLES. FOR MORE DETAILS OF LIGHT POLES INCLUDING LED LUMINAIRES, SEE SHEET LT-5. FOR OTHER ELECTRICAL DETAILS, SEE SHEET LT-6.
- EXISTING CONTROLLER CABINET SHALL BE USED FOR PROPOSED LIGHTING UNITS AND RECEPTACLES TO BE MOUNTED ON MAIN STREET AS SHOWN ON THIS SHEET. SEPARATE CIRCUITS SHALL BE USED TO PROVIDE 120V FEED TO RECEPTACLES.
- FOR LAYING THE PROPOSED CONDUITS AND CABLES, THE CONTRACTOR SHALL PAY SPECIAL ATTENTION NOT TO DAMAGE PROPOSED BRICK WORKS, NEW PLANTERS AND TREES.

- 7. UCGS STANDS FOR UNDERGROUND CONDUIT GALVANIZED STEEL.
- 8. THE WIRE SIZE OF ALL POWER CABLE IS NO. 4, AND NO. 6 FOR GROUNDING. THE PROPOSED WIRING DETAILS ARE AS FOLLOWS: FOR TYPE A AND TYPE B LIGHTING UNITS, USE 2 HOT NO. 4 WIRES FOR LED LUMINAIRES TO GET FEED OF 240V. FOR RECEPTACLES PROVIDED WITH TYPE B POLES, USE ONE HOT AND NEUTRAL NO. 6 WIRES TO GET 120V FEED.
- 9. GROUND WIRE SHALL BE COMMON FOR ALL CIRCUITS.
- 10. THE PROPOSED ELECTRIC CABLE 7-1/C NO. 4, 1/C NO. 6 GROUND SHALL BE PULLED THROUGH THE EXISTING AND PROPOSED CONDUIT FROM THE EXISTING CABINET TO THE PROPOSED LIGHTING UNIT. THE EXISTING HANDHOLE SHALL BE DRILLED TO ACCOMMODATE THE NEW 4" DIA. CONDUIT.

LT-3

AMES Engineering, Inc.
CONSULTING ENGINEERS
6330 Belmont Road, Sulte 4B
Downers Grove, IL 60515


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	DRAWN -	SR	REVISED -
PLOT SCALE = \$SCALE\$	CHECKED -	BL	REVISED -
PLOT DATE = \$DATE\$	DATE -	05-11-2022	REVISED -

STATI	E OI	F ILLINOIS	
DEPARTMENT	0F	TRANSPORTATION	

SCALE:

PROPOSED LIGHTING PLAN			F.A.U RTE	SECTION		COUNTY	TOTAL SHEETS	SHEET NO.			
	MAIN STREET, CITY OF ROCKFORD			0002			WINNEBAGO	21	12		
							CONTRACT	NO.			
	SHEET	OF	SHEETS	STA.	TO STA.		ILLINOIS	FED. A	ID PROJECT		



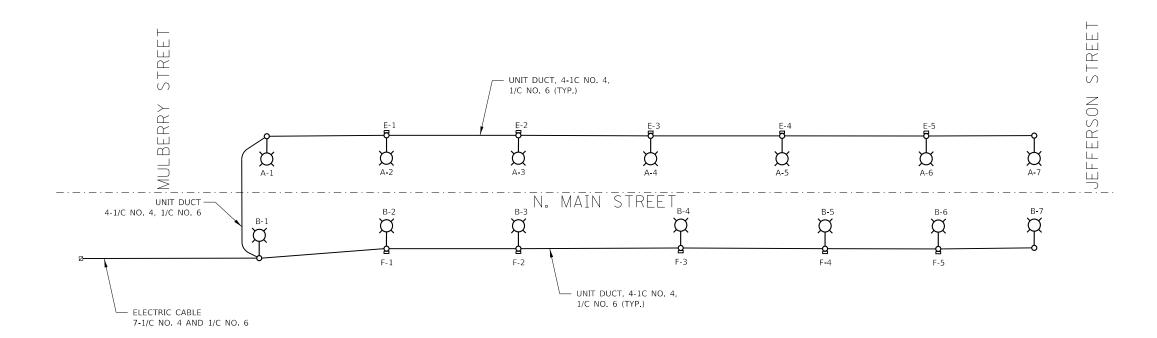

<u>LEGEND</u>

O—C LUMINAIRE, LED, 240V, 0.6A, 125W, ON TYPE A POLE



LUMINAIRE, LED, 240V, 0.30A, 66W, ON TYPE B POLE WITH 120V GFCI WEATHERPROOF RECEPTACLE

——— CABLE AS INDICATED

NOTES:

- 1. FOR FEED TO 240V LED LUMINAIRES AND 120V RECEPTACLES, SEE POLE WIRING DETAIL ON SHEET LT-6.
- 2. TO GET THE POWER FEED TO PROPOSED TYPE A AND TYPE B LIGHT POLES AND GFCI RECEPTACLES USE THE EXISTING LIGHTING CABINET BY EXTENDING AND CONNECTING THE PROPOSED WIRING TO IT.

	_
A	,
	c
	6

_	AMES Engineering,	Inc
▲	CONSULTING ENGINEERS	
	6330 Belmont Road, Sulte 4B	
	Downers Grove, IL 60515	

g, Inc.	USER NAME
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4B	PLOT SCAL
	PLOT DATE


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	DRAWN -	SR	REVISED -
PLOT SCALE = \$SCALE\$	CHECKED -	BL	REVISED -
PLOT DATE = \$DATE\$	DATE -	05-11-2022	REVISED -

STATI	E OI	FILLINOIS
DEPARTMENT	OF	TRANSPORTATION

	LE LINE W Street, (D
SHEET	OF	SHEETS	CTA	TO STA.
SHEET	UF		DIA.	IU SIA.

F.A.U RTE	SECT	ΠΟN		COUNTY	TOTAL SHEETS	SI
0002			WINNEBAGO	21		
				CONTRACT	NO.	
		ILLINOIS	ID PROJECT			

LT-4

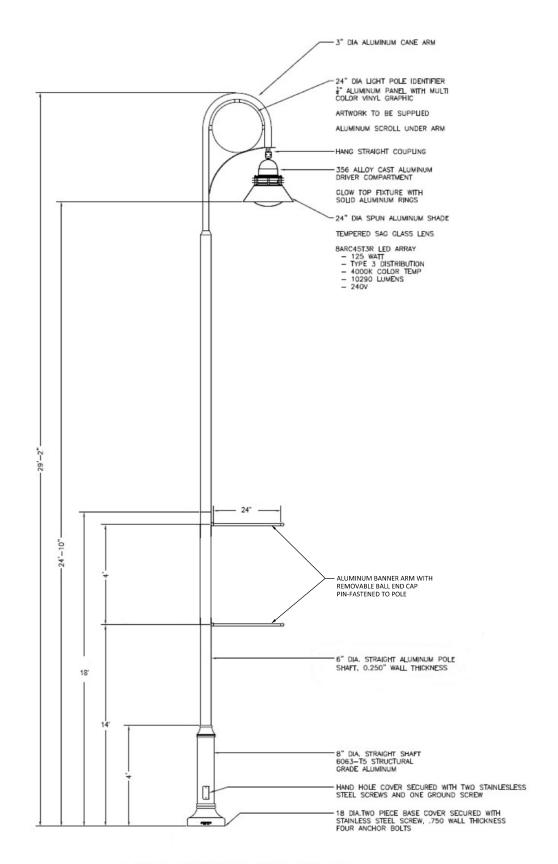






LIGHT POLE IDENTIFIER

BOLT CIRCLE

TYPE A AND TYPE B LIGHT POLES SHALL BE PROVIDED WITH BANNER ARMS OR PLANTER BASKETS AS SHOWN ON PLANS.

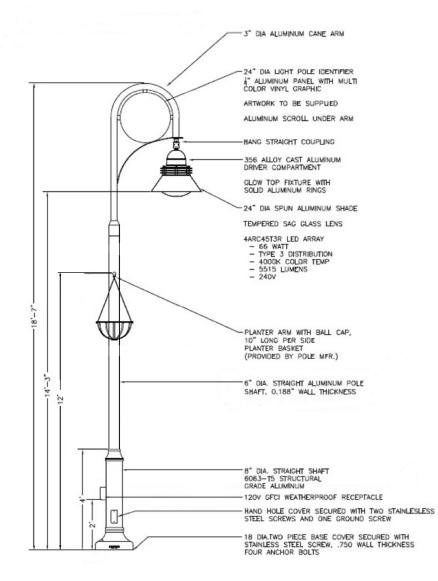

TYPE B LIGHT POLE DETAIL

SCALE:

11/2 ROCKFORD 111

STREETSCAPE LIGHTING UNIT **DETAILS**

TYPE A LIGHT POLE DETAIL

DATE: 01/05/2016 STANDARD MAIN STREET, CITY OF ROCKFORD OF SHEETS STA. TO STA. SHEET


COUNTY TOTAL SHEET NO.
WINNEBAGO 21 14 SECTION 0002 CONTRACT NO.

LT-5

AMES Engineering, Inc. CONSULTING ENGINEERS 6330 Belmont Road, Sulte 4B Downers Grove, IL 60515

JSER NAME = \$USER\$ DESIGNED - MB REVISED DRAWN - SR REVISED CHECKED - BL REVISED PLOT DATE = SDATES - 05-11-2022 REVISED DATE

STATE OF ILLINOIS **DEPARTMENT OF TRANSPORTATION**

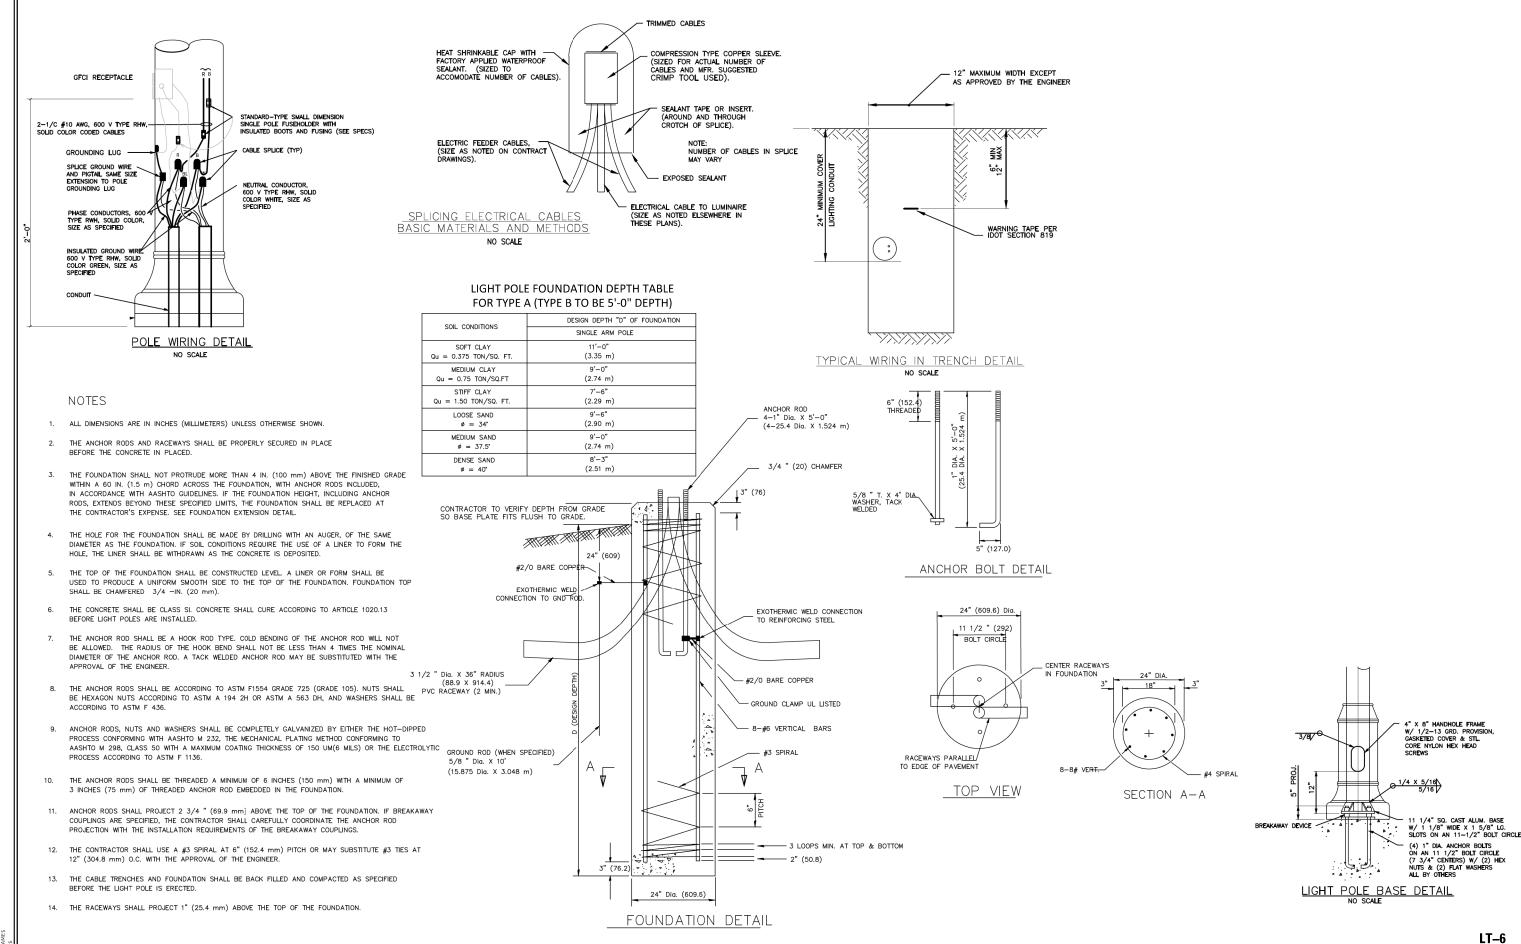

AMES Engineering, Inc.

CONSULTING ENGINEERS
6330 Belmont Road, Suite 4B
Downers Grove, IL 60515

USER NAME = SUSERS

DESIGNED - MB REVISED
DRAWN - SR REVISED
BL REVISED
REVISED
PLOT SCALE = SOCALES

DATE - 05-11-2022

REVISED -

STATE OF ILLINOIS
DEPARTMENT OF TRANSPORTATION

MASONRY WALL CONSTRUCTION

Description.

- A. This work consists of constructing unit masonry assemblies consisting of the following:
 - 1. Concrete masonry units.
 - 2. Mortar and grout.
- B. Concrete masonry shown on drawings will function as a closure for the existing openings.
- C. Provide unit masonry that develops the following net-area compressive strengths (f'm) at 28 days. Determine compressive strength of masonry by testing masonry prisms according to ASTM C 1314.
- D. For Concrete Unit Masonry: f'm = 1500 psi.

<u>Materials.</u>

The concrete blocks shall meet requirements of Article 1005.02 and the following:

Concrete Masonry Units: ASTM C 90 and as follows:

- Unit Compressive Strength: Provide units with minimum average net-area compressive strength of 1900 psi.
- 2. Weight Classification: Normal weight.
- 3. Size (Width): Manufactured to the following dimensions:

12 inches nominal; 11-5/8 inches actual.

Reinforcement Bars: ASTM A $615~{\rm Gr.~60}$ in conformance with the Section $508~{\rm of}$ the Standard Specifications.

Preblended, Dry Mortar Mix: Furnish dry mortar ingredients in the form of a preblended mix. Type M, ASTM C270.

Grout for filling cells and bond beams shall conform to ASTM C476. Grout shall have a minimum compressive strength of 2000 psi at 28 days. Grout shall be a "coarse grout" including 3/8" coarse aggregate.

Placement.

- A. Lay masonry in the following bond pattern.
 - Running bond with vertical joint in each course centered (+/- 4") on units in courses above and below.
- B. Lay hollow masonry units as follows:
 - With full mortar coverage on horizontal and vertical face shells.
 - Bed webs in mortar in starting course.
- C. Tool exposed joints slightly concave when thumbprint hard, using a jointer larger than the joint thickness, unless otherwise indicated.
- D. Pointing: During the tooling of joints, enlarge voids and holes, except weep holes, and completely fill with mortar. Point up joints, including corners, openings, and adjacent construction, to provide a neat, uniform appearance. Prepare joints for sealant application.

Alternative Wall Type.


- A. The Contractor may construct a reinforced concrete wall as a substitution for Masonry Wall Construction. If the Contractor chooses this alternative, the following requirements apply:
 - Wall shall be 11 1/2" to 12" thick.
 - The dowels and reinforcing bars shown for the Masonry Wall Construction shall be used. Horizontal #5 bars at 16" on center
 - Class SI concrete shall be utilized in accordance with Section 503 of the Standard Specifications.

<u>Debris Removal</u>

A. Remove all debris in the vault that is in the Right of Way and dispose at a proper facility. Debris shall be considered Clean Construction Debris.

BILL OF MATERIALS

ITEM	UNIT	TOTAL
Debris Removal	LSUM	1
Masonry Wall Construction	SF	270
Geocomposite Wall Drain	SY	37
CA-7 Drainage Stone	Ton	210
FilterFabric	SY	42

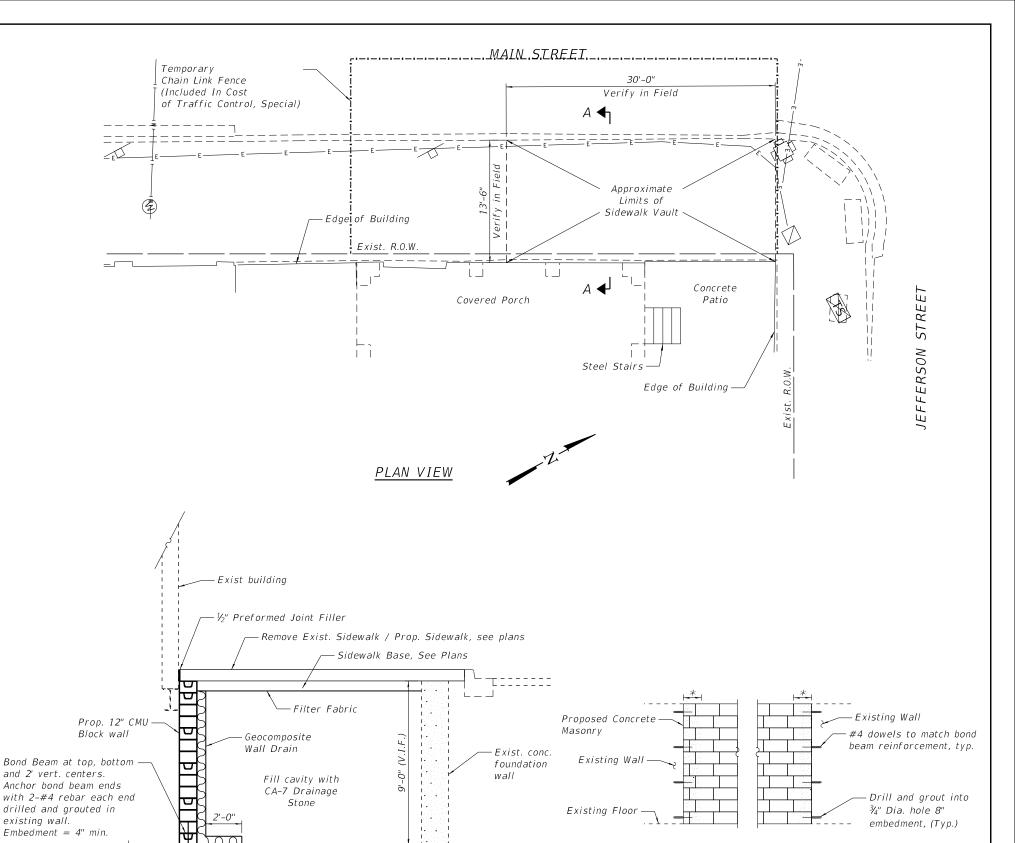

- Exist conc. floor slab

-Break up or Core 4" holes

at 4'-0" cts. for drainage

SECTION A-A

Note: Remove all debris from vault prior to filling.

STATE OF ILLINOIS DEPARTMENT OF TRANSPORTATION

Anchor wall with #4 rebar,

in exist. floor.

Embedment = 8" min


1'-6" long, drilled and grouted

MASONRY CLOSURE DETAIL

* Grout cores solid 8"-12"

from existing wall.

HRG PROJ. CONTACT.
FILE NAME: 2/0686_STr_VouT.dgn
PLOT DRIVER: IL.pdf.bw.pHcfg
PEN TABLE: plot/dou/tb/

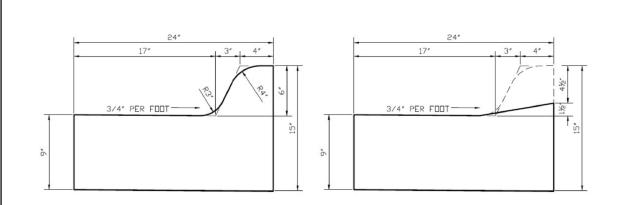

Combination Concrete Curb & Gutter, Type M6.18 Modified

CONCRETE CURB AND GUTTER SHALL BE CONSTRUCTED IN ACCORDANCE WITH SECTION 606 OF THE STANDARD SPECIFICATIONS, SUPPLEMENTAL SPECIFICATIONS, STANDARD 606001 AND THIS DRAWING

CLASS SI CONCRETE SHALL BE USED THROUGHOUT. A HOLE 1-1/2 IN DIAMETER AND 9 DEEP SHALL BE DRILLED IN THE EXISTING CONCRETE CURB AS SHOWN. A 1-1/4 X 18 SMOOTH DOWEL BAR SHALL BE GROUTED IN THE HOLE LONGITUDINALLY.


JOINTS OF A TYPE SIMILAR TO THAT IN THE UNDER-LYING PAVEMENT (EXPANSION OR CONTRACTION) SHALL BE INSTALLED IN THE CONCRETE CURB IN ALIGNMENT

THE PROPOSED CONFIGURATION OF THE CURB AND GUTTER SHALL MATCH THAT REMOVED.

THE LOCATION OF THE DOWEL BAR SHALL BE DETERMINED

ALL EXISTING TIE BARS IN EDGE OF PAVEMENT SLAB THRU REPLACEMENT AREA SHALL BE CUT OFF.


THE WORK SHALL BE DONE IN ACCORDANCE WITH SECTION 602 OF THE STANDARD SPECIFICATIONS AND INCLUDES THE REMOVAL AND REPLACEMENT OF SOD, CONCRETE PAVEMENT AND/OR CURB AND GUTTER ADJACENT TO CATCH BASINS OR INLETS TO BE ADJUSTED OR RECONSTRUCTED AND SHALL BE INCLUDED IN THE PAY ITEM OF CATCH BASINS OR INLETS TO BE ADJUSTED OR RECONSTRUCTED AS SPECIFIED.

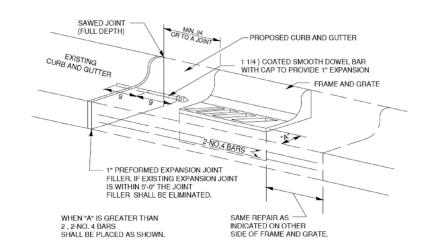


ALL DIMENSIONS ARE IN INCHES UNLESS OTHERWISE NOTED.

(DETAILS FOR CURB & GUTTER REPLACEMENT)

SCALE: N.T.S.

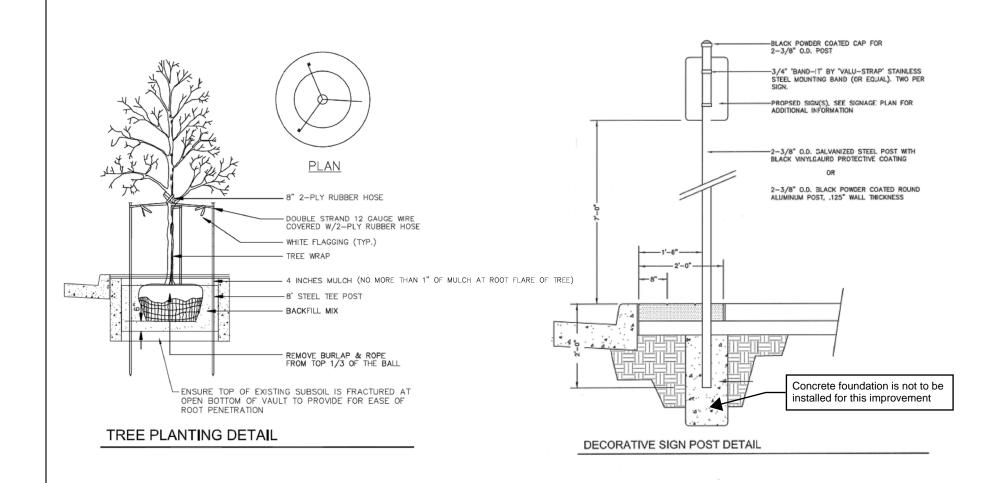

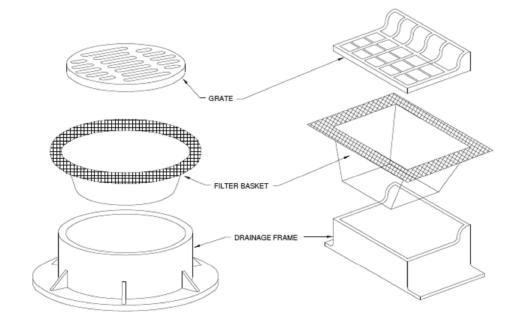

DRAINAGE STRUCTURE FILTER BASEKET

NOT TO SCALE

NOTES

- FILTER BASKETS SHALL BE PLACED IN ALL EXISTING AND PROPOSED INLETS, MANHOLES. TRENCH DRAINS AND CATCH BASINS LOCATED IN PAVED AREAS AND NON-PAVED AREAS.
- FABRIC SHALL BE IN CONFORMANCE WITH MATERIALS SPECIFIED FOR SILT FENCE.
- FILTER BASKET SHALL OVERLAY FRAME BY 6" (MIN.).
- CONTRACTOR SHALL CLEAR DEBRIS AND SILT AS REQUIRED FROM BASKET TO MAINTAIN DRAINAGE THROUGH THE STRUCTURE.
- ALL BASKETS SHALL REMAIN IN PLACE UNTIL THE CONSTRUCTION IS COMPLETED.
- DRAINAGE STRUCTURE FILTER WRAP DETAIL SHALL ONLY BE USED FOR THE DRAINAGE STRUCTURE AT STATION 61+23 RT. ALL OTHER DRAINAGE STRUCTURES SHALL USE FILTER BASKETS.
- FILTER WRAP AND SANDBAGS SHALL BE PAID FOR WITH PAY ITEM "28000510 INLET FILTERS"

NO.: 2/08 ITACT: 1686_Sh1 IL_pdf_t	
PROJECT NO.: 2100 PROJ. CONTACT: NAME: 210686_Sht DRIVER: IL_pdf_L	
001157	. 1

HRGreen.com


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PLOT SCALE = 2.0000 / in.	CHECKED -	REVISED - XX/XX/XXXX
PLOT DATE = 5/17/2022	DATE -	REVISED - XX/XX/XXXX

STATE OF ILLINOIS **DEPARTMENT OF TRANSPORTATION**

	CONSTRUCTION DETAILS MAIN STREET							F.A. RTE	SECT	ION		COUNTY	TOTAL SHEETS	SHEET NO.	
											WINNEBAGO	21	17		
											CONTRACT	NO.			
	SHEET	1	OF	1	SHEETS	STA	TO 9	STA			RELIMOIS	EED AL	D PROJECT		

WORK ZONE SIGN DETAILS

ILLINOIS STANDARD G20-I100

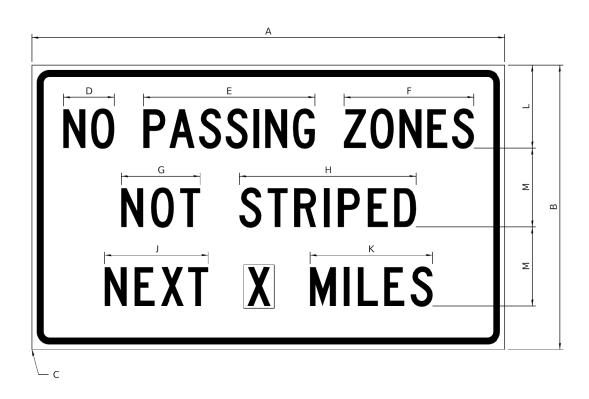

COLOR LEGEND AND BORDER BACKGROUND

BLACK ORANGE

NON-REFLECTORIZED REFLECTORIZED

SIGN SIZE					[DIMEN	ISIONS	5				
	А	В	С	D	Е	F	G	Н	J	К	L	М
60 x 36	60.00	36.00	2.25	6.4	21.80	16.40	10.00	22.40	13.20	15.50	10.50	10.00

SIGN SIZE	SER	IES BY	LINE	MARGIN	BORDER	
SIGN SIZE	1	2	3	MARGIN	BONDEN	
60 x 36	5C	5C	5C	0.625	0.875	

Sign not to scale

GENERAL NOTES


All work to furnish and install these signs shall be included in the cost of the specified traffic control standards and shall not be paid separately.

All Illinois Standard signs shall conform to the latest edition of the "Illinois Standard Highway Signs Book" in effect on the date of invitation for bids.

Signs shall meet the applicable portions of Sections 701 and 720 of the Standard Specifications.

All dimensions are in inches unless otherwise noted.

ILLINOIS STANDARD W8–I107

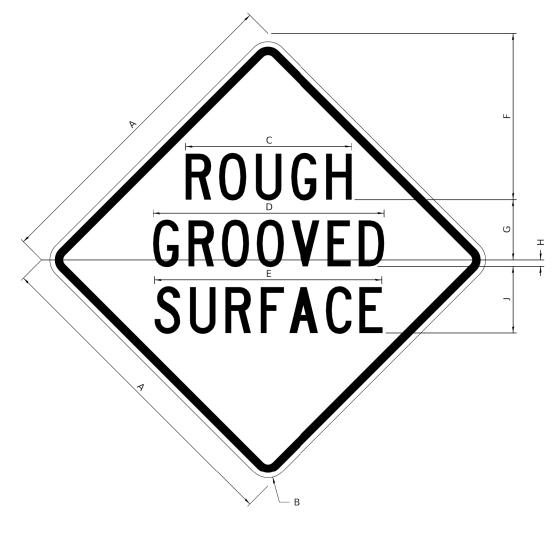

COLOR LEGEND AND BORDER BACKGROUND

BLACK ORANGE NON-REFLECTORIZED REFLECTORIZED

SIGN SIZE		DIMENSIONS								
	Α	В	С	D	Е	F	G	Н	J	
48 x 48	48.00	3.00	25.00	34.80	34.20	24.94	9.00	1.00	10.00	

SIGN SIZE	SER	IES BY	LINE	MARGIN	BORDER
	1	2	З	MARGIN	BORDER
48 x 48	7C	7C	7C	1.250	0.750

Sign not to scale


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FILE NAME: District 2 Standard		DRAWN -	REVISED -	
	PLOT SCALE = 1.0000 * / in.	CHECKED -	REVISED -	
	PLOT DATE = 1/11/2022	DATE -	REVISED -	

STATE OF ILLINOIS
DEPARTMENT OF TRANSPORTATION

REGION	12/	DISTRICT	2 STANDARD	
SHEET 1	OF	4 SHEETS	STA.	TO ST

WORK ZONE SIGN DETAILS

ILLINOIS STANDARD W12–I102

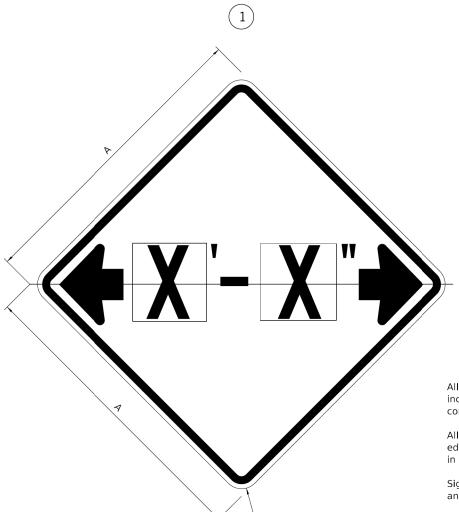

GENERAL NOTES

All work to furnish and install these signs shall be included in the cost of the specified traffic control standards and shall not be paid separately.

All Illinois Standard signs shall conform to the latest edition of the "Illinois Standard Highway Signs Book" in effect on the date of invitation for bids.

Signs shall meet the applicable portions of Sections 701 and 720 of the Standard Specifications.

All dimensions are in inches unless otherwise noted.

COLOR LEGEND AND BORDER BACKGROUND

BLACK FL ORANGE NON-REFLECTORIZED REFLECTORIZED


SIGN SIZE	DIMENSIONS					
SIGN SIZE	Α	В				
48 x 48	48.00	3.00				

Illinois Standard signs W12-I102 and W12-I103 shall be used as described in the special provisions.

SIGN SIZE	SERIES BY LINE	MADCIN	BODDED
SIGN SIZE	1	MARGIN BORDE 0.750 1.250	BORDER
48 x 48	12C	0.750	1.250

Sign not to scale

ILLINOIS STANDARD W12–I103

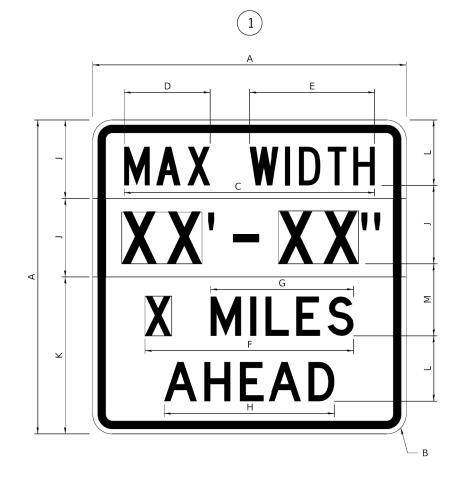

COLOR

LEGEND AND BORDER
BACKGROUND
BACKGROUND (WIDTH)

BLACK WHITE FL ORANGE NON-REFLECTORIZED REFLECTORIZED REFLECTORIZED

SIGN SIZE					[DIMEN	SIONS	5				
	Α	В	С	D	Е	F	G	Н	J	К	L	М
48 x 48	48.00	3.00	38.40	13.20	19.20	32.00	22.00	26.20	12.00	24.00	10.00	11.00

CICN CIZE	,	SERIES	BY LINE	MARGIN	BORDER		
SIGN SIZE	1	2	3	4	MARGIN	BORDER	
48 x 48	6C	8D	6D	6D	0.750	1.250	

Sign not to scale

XX'-XX" WIDTH AND X MILES ARE VARIABLE TOP AND BOTTOM OF BACKGROUND WHITE

	USER NAME = IDOT/District 2	DESIGNED -	REVISED - 3-02-16
FILE NAME: District 2 Standard		DRAWN -	REVISED -
	PLOT SCALE = 1.0000 * / in.	CHECKED -	REVISED -
	PLOT DATE = 1/11/2022	DATE -	REVISED -

STATE OF ILLINOIS DEPARTMENT OF TRANSPORTATION

REGION	2 / DI	STRICT 2	2 STANDARD	
SHEET 2	OF 4	SHEETS	STA.	TO STA.

A.U SECTION COUNTY TOTAL SHEETS NC
WINNEBAGO 21 19
CONTRACT NO.

WORK ZONE SIGN DETAILS

ROAD CLOSED TO OVERSIZED LOADS



LEGEND AND BORDER BACKGROUND

BLACK ORANGE


NON-REFLECTORIZED REFLECTORIZED

Permit Loads - Loads Over 13 Feet; 3.0" Radius, 1.3" Border; [NO OVERSIZE -] D; [OVERWEIGHT LOADS] D 85% spacing; [XX MILES AHEAD] D; Table of letter and object lefts.

N 11.7	O 18.1	O 30.0	V 36.2	E 42.8	R 48.4	S 54.4	I 60.7	Z 63.5	E 69.5	- 80.8				
O 2.6	V 8.6	E 15.0	R 20.4	W 26.2	E 33.4	I 38.8	G 41.3	H 47.4	T 53.2	L 64.5	O 69.9	A 75.9	D 82.9	S 88.7
X 7.6	X 13.6	M 25.3	I 32.3	L 35.1	E 40.6	S 46.2	A 57.9	H 65.1	E 71.4	A 76.6	D 83.7			

Sign not to scale

STOP LINE SIGN FOR TEMPORARY SIGNALS

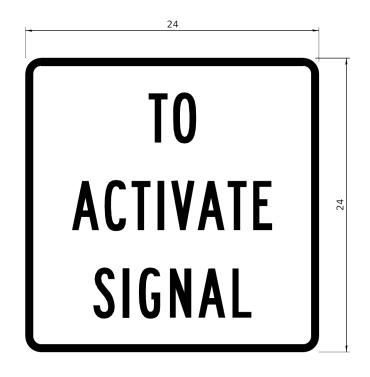

LEGEND AND BORDER BACKGROUND

BLACK WHITE NON-REFLECTORIZED REFLECTORIZED

SIGN SIZE	SERIES BY LINE						
SIGN SIZE	1	2	3				
24 x 24	4C	4C	4C				

Sign not to scale

GENERAL NOTES

All work to furnish and install these signs shall be included in the cost of the specified traffic control standards and shall not be paid separately

All Illinois Standard signs shall conform to the latest edition of the "Illinois Standard Highway Signs Book" in effect on the date of invitation for bids.

Signs shall meet the applicable portions of Sections 701 and 720 of the Standard Specifications.

All dimensions are in inches unless otherwise noted

FILE NAME: District 2 Standard

USER NAME = IDOT/District 2	DESIGNED -	REVISED - 3-02-16
	DRAWN -	REVISED -
PLOT SCALE = 1.0000 ' / in.	CHECKED -	REVISED -
PLOT DATE = 1/11/2022	DATE -	REVISED -

STATE OF ILLINOIS	
DEPARTMENT OF TRANSPORTATION	


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CHEET	2	0.5	4	CHEETC	CTA		TO CT4				

WINNEBAGO CONTRACT NO.

21

ENTRANCE SIGN FOR USE WITH TEMPORARY SIGNALS

WORK ZONE SIGN DETAILS

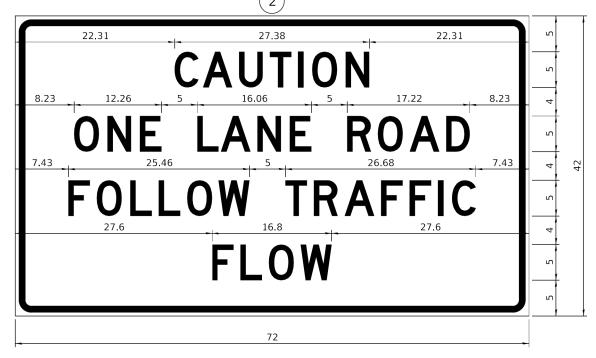

COLOR

LEGEND AND BORDER BACKGROUND

BLACK ORANGE NON-REFLECTORIZED REFLECTORIZED

2.25" Radius, 0.88" Border, 0.50" IndenT; [CAUTION] D; [ONE LANE ROAD] D; [FOLLOW TRAFFIC] D; [FLOW] D

This sign shall be installed at entrances located between the temporary signals as shown in the staging plans.

Table Of Widths And Spaces

	С		Α		U		Т		I		О		N	
22.31	3.36	0.62	4.18	0.94	3.36	0.94	3.04	0.94	0.78	1.17	3.52	1.17	3.36	22.31

	0		Ν		Е
8.23	3.51	1.17	3.36	1.18	3.04

	L		Α		N		Е
5.00	3.05	0.31	4.18	0.94	3.36	1.17	3.05

	R		0		Α		D	
5.00	3.36	0.93	3.52	0.94	4.18	0.93	3.36	8.23


	F		0		L		L		0		W
7.43	3.04	0.94	3.52	1.17	3.04	0.94	3.05	0.94	3.51	0.94	4.37

5.00	T 3.05	0.94	R 3.36	0.94	A 4.18	0.93	F 3.05	0.94	F 3.04	0.94	I 0.78	1.18	C 3.35	7.43
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	F		L		0		W	
27.60	3.05	0.94	3.04	0.94	3.52	0.93	4.38	27.60

Sign not to scale

STAY IN YOUR LANE

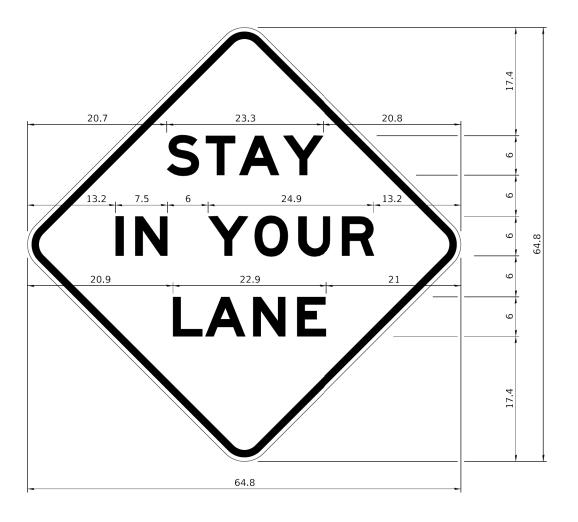

COLOR

LEGEND AND BORDER BACKGROUND

BLACK ORANGE NON-REFLECTORIZED REFLECTORIZED

48.0" across sides 3.8" Radius, 1.0" Border, 0.6" Indent; "STAY" E Mod; "IN YOUR" E Mod; "LANE" E Mod;

Table of Letter and Object Lefts

S T A Y 20.7 26.8 31.6 38.0

L	Α	N	Е
20.9	25.8	33.1	39.4

Sign not to scale

							_							
	USER NAME = IDOT/District 2	DESIGNED -	REVISED - 3-02-16							F.A.U RTF	SECTION	COUNTY	TOTAL	. SHEET
FILE NAME: District 2 Standard		DRAWN -	REVISED -	STATE OF ILLINOIS		REGION 2 / DIST	RICT 2	STANDA	RD	1112.		WINNEBAGO	21	21
	PLOT SCALE = 1.0000 ' / in.	CHECKED -	REVISED -	DEPARTMENT OF TRANSPORTATION								CONTRAC		_
	PLOT DATE = 1/11/2022	DATE -	REVISED -		SCALE:	SHEET 4 OF 4 S	SHEETS	STA.	TO STA.		ILLINOIS FED.	AID PROJECT		

GENERAL NOTES

All work to furnish and install these signs shall be included in the cost of the specified traffic control standards and shall not be paid separately.

All Illinois Standard signs shall conform to the latest edition of the "Illinois Standard Highway Signs Book"

Signs shall meet the applicable portions of Sections 701

All dimensions are in inches unless otherwise noted.

in effect on the date of invitation for bids.

and 720 of the Standard Specifications.